

Community Improvement Program Accessibility Plan Submission

Project Identification

Location of the Project: 39 Athol Street West

Developer: Central Clear View Developments

Date of Submission: June 11, 2025

External Features

1. Accessible Parking Stall Location, Signage, Type, and Size Reference: Oshawa Accessibility Design Standards (OADS) 3.1 Pages 55-59

OADS Requirements

Meets Standards

Explain: Accessible parking spaces Type A & Type B have been evenly provided across parking levels P1, L1, L2, & L3 in proximity to lobby entrances. Pavement and vertical signage will be provided per OADS. PDO's are provided on door entrances from parking areas to elevator lobbies.

2. Number of Accessible Parking Stalls Reference: Oshawa Accessibility Design Standards (OADS) 3.1.2 Page 56

OADS Requirements

Meets Standards

Explain: There are a total of 127 parking spaces which generates a requirement of two (2) type A and three (3) type B parking spaces (as per OADS). Two (2) type A and three (3) type B parking spaces are to be provided across parking levels. All

parking spaces are provided with access aisles, with pavement markings and signage posted in front of the stalls (wall mounted).

3. Accessible Parking Space - Access Aisle

Reference: Oshawa Accessibility Design Standards (OADS) 3.1.3 Pages 57-58

OADS Requirements

Meets Standards

Explain: Accessible parking spaces meet OADS requirements including surface material and lighting. Parking spaces located in proximity to elevator lobbies. Type A spaces dimensions are 3400mm X 5400mm X 2100H and Type B spaces dimensions are 2600mm X 5400mm X 2100H. There will be a 1500mm access aisle adjacent of the accessible parking spaces.

4. External Accessible Routes, Paths and Amenity Areas

Reference: Oshawa Accessibility Design Standards (OADS) 2.6; 2.7; 2.8; 3.3; 6.17; 6.18; 6.19 Pages 37-38; 39-40; 41-44; 65-69; 215-226

OADS Requirements

Meets Standards

Explain: The residential lobby entrance is accessed directly from the sidewalk along Centre Street South, and commercial unit have direct access from the sidewalk along Athol Street West. All sidewalk cuts will include curb ramps per OADS details.

5. Passenger/Transit Loading and Drop Off Zones

Reference: Oshawa Accessibility Design Standards (OADS) 3.2 Page 61-63

OADS Requirements

Not Applicable

Explain: There are no designated passenger/transit loading or drop-off zones at the site.

6. Curb Ramps

Reference: Oshawa Accessibility Design Standards (OADS) 3.4 Pages 71-75

OADS Requirements

Meets Standards

Explain: All sidewalk curb cuts to employ curb ramps per OADS details. Curb ramps will be provided at existing intersection curb cut. All curb ramps will have tactile identification strips. It was requested by engineering that a continuous sidewalk be provided at the driveway entrance off Athol St, eliminating the need for a grade change, curb ramps and tactile plates.

7. Ramps

Reference: Oshawa Accessibility Design Standards (OADS) 2.2; 2.7 Pages 21-26; 39-40

OADS Requirements

Meets Standard

Explain: The parking garage ramps will accommodate accessible van access. Ramps in the back of house servicing ground floor lobby, bulky waste & moving room will be built with a max 7.1% slope and proper accessibility handrails as per drawing OADS-51.

8. External Ground Surfaces, Colour Contrast

Reference: Oshawa Accessibility Design Standards (OADS) 2.1 Pages 17-20

OADS Requirements

Meets Standards

Explain: The external ground surfaces meet the OADS requirements. All accessible routes will have either cast-in-place saw-cut concrete as stable, firm, slip resistant and glare-free, tactile walking surface indicators will be located at each curb ramp as per City standards.

9. External Signage

Reference: Oshawa Accessibility Design Standards (OADS) 5.8 Pages 143-148

OADS Requirements

Meets Standards

Explain: As per OADS 5.8, Directional signage placed in the ground level area to direct traffic to parking garage entrance and fire routes, all with required contrasting colours, characters, and symbols. Commercial signage will be properly provided as per OADS when appropriate tenants are in place. Prior to installation, the project team will submit for the Oshawa Community Improvement Program Approval. A sign will be placed on the building to reference the location of the main accessible

entrance on Centre Street East designed as per Oshawa Accessibility Design Standards (OADS). Additional signage may be considered to direct visitors to the nearest City Parking Lot.

10. External Lighting

Reference: Oshawa Accessibility Design Standards (OADS) 5.7 Page 139-141

OADS Requirements

Meets Standards

Explain: Existing Street lighting is by the City. Exterior paths will meet the standards per OADS 5.7. The primary accessible route will be lit to 30 lux, and accessible entrances to 100 lux

11. External Doors

Reference: Oshawa Accessibility Design Standards (OADS) 4.2 Pages 81-91

OADS Requirements

Meets Standards

Explain: The main residential entrance (including vestibules) and all interior and exterior common amenity space doors (on Ground Level, 2^{nd} , 6^{th} & 18^{th} floor) will be equipped with power door operators. The main entrance door will be 910mm clear wide swing door, which is large enough to permit an accessibility device to pass through unimpeded. A sliding door with auto activation will be considered. The commercial space door will be a minimum clear width of 910mm. All doors will have the minimum OADS requirements for maneuvering space as a front approach of 1525mm x 1600mm, with sufficient 1370 x 1250mm space on the push side. Vestibules will also include sufficient clearance in series with 1500mm

12. External Facility Amenity Areas - Furniture/Play/Social Areas

Reference: Oshawa Accessibility Design Standards (OADS) 2.6; 2.10 Pages 37-38, 49-51

OADS Requirements

Meets Standards

Explain: Resting benches will be provided adjacent to the main residential entrance as per OADS. Residents and visitors will be able to use these when travelling along Centre Street South & Athol Street West

Internal Features

A. Accessible Suites – Quantity

Total Number of Suites: 204

Total Number of Accessible Suites: 31, 3 of which are upgraded accessible suites.

Percentage of Suites that are Accessible: 15%

Total Number of Bedrooms: 304

Total Number of Accessible Bedrooms: 31

Percentage of Bedrooms that are Accessible: 10%

B. Common Entrances, Vestibules, Hallways, Doors and Exits Reference: Oshawa Accessibility Design Standards (OADS) 4.1; 4.2; 4.3 Pages 79-80, 81-91, 93-96

Number of entrances: One Residential Lobby & one retail space at ground floor.

Number of accessible entrances: One accessible entrance to residential lobby & one accessible entrance to retail space.

Ease of access/egress: The residential entrance (**not suite doors**) swing door is 910mm clear with a power door operator as per OADS. The entrance door will have the minimum OADS requirements for maneuvering space as a side approach of 1370 x 1830mm, with a sufficient front approach of 1525mm x 1600mm, unless provided with power door operators. The entrance will lead into a vestibule with internal doors **also connected to power door operators**. Vestibules will also include sufficient clearance in series with 1600mm. Hallways will all be 1100mm wide as per OADS. There will be a 1800mm x 1800mm area in levels 6-18 where the length of the hallway is more than 30m. Accessible signage following OADS standards (including braille, color contrast, etc.) to be provided throughout to assist guests with hearing or vision disabilities.

Power Door Operators: Explain (location, type) A power door operator will be provided at the main entrance and all interior & exterior amenity doors on level 1, 2, 6 & 18.

C. Common Facility Entrance - Lobby, Reception Area, Mailroom

Reference: Oshawa Accessibility Design Standards (OADS) 2.10; 5.1; 5.2; 5.3; 5.5 Pages 49-51, 123-125, 127-128, 129-130

Counter heights of each: The on-site management office has a reception desk that will include a lowered counter set at a maximum height of 850MM and with a floor

clearance for 915 x 1370 x 685. The resident mailboxes, with a number of mailboxes set between 900 and 1200mm that can be assigned to accessible units.

Dimensions of each: Lobby Area 6.5m x 14.0m. Mailroom Area 1.6m x 3.2m

Accessible features of Guest/Suite Notification System (i.e. audio, visual, Braille): There will be audio and visual systems in place from the main door and the individual suites to notify residents if they have a guest present. This will be in place for both residents and guests with hearing or vision disabilities.

Ease of access/egress: (dimensions, curb ramps, path of travel) Hallway will be 1600mm and there will be space beside doors in the path of travel as per OBC requirements.

Access to commercial areas (street access; within building access; power door operators): Level entrance to building will be provided from sidewalk with power door operators. Lobby doors are also power operated.

Power Door Operators: Explain (location, type): Power Door Operators will be installed on the commercial unit and lobby entrance doors. Conforming to OADS

D. Common Facility Areas – Laundry, TV/Party, Game Rooms Reference: Oshawa Accessibility Design Standards (OADS) 5.4; 6.2; 6.7; 6.10 Pages

There are several common areas proposed in the building:

The common areas in parking levels include tenant lockers and elevator lobbies. PDO's to be provided to all doors servicing elevator lobbies at parking levels. Locker room at P1 to be equipped with PDO's. P1 Locker room will accommodate lockers associated with accessible units. These lockers will conform to AODA/OADS requirements including accessible path/turning radius.

The common area in level 1 includes residential lobbies with a lounge for residents, pet wash, and retail area. An accessible washroom is provided at level 1 for residents. All level 1 common amenity areas to be equipped with PDO's. Accessible path of travel to be maintained, with space provided between furniture. Colour contrasting finishes to be selected in accordance with OADS standards. Directional signage to be provided throughout following OADS standards.

The level 2 common area is a gym with an accessible washroom being provided for residents. All level 2 common amenity areas to be equipped with PDO's. . Accessible flintiness equipment to be considered, with accessible path of travel maintained. Colour contrasting finishes to be selected in accordance with OADS standards. Directional signage to be provided throughout following OADS standards.

The level 6 common area includes a kids play room and business center. A accessible washroom is provided at this level for residents. An outdoor amenity terrace will be accessible with barrier free access and doors equipped with PDO. All level 6 common amenity areas to be equipped with PDO's. Accessible path of travel to be maintained, with space provided between furniture. Colour contrasting finishes to be selected in accordance with OADS standards. Directional signage to be provided throughout following OADS standards. All outdoor amenity spaces to be provided with an accessible path (i.e step-free access and/or threshold cover ramps to be provided).

The level 18 common area includes an entertainment room and party room. Two washrooms are provided for residents with one being universal. The universal washroom will be fully equipped with emergency call system and adult change table. An outdoor amenity terrace will be accessible with barrier free access and doors equipped with PDO. All level 18 common amenity areas to be equipped with PDO's. Accessible path of travel to be maintained, with space provided between furniture. Colour contrasting finishes to be selected in accordance with OADS standards. Directional signage to be provided throughout following OADS standards. All outdoor amenity spaces to be provided with an accessible path (i.e step-free access and/or threshold cover ramps to be provided).

All common areas and accessible washrooms will have power door operators. All common amenity rooms will have appropriate maneuvering spaces at entry/exit. A minimum of 1100mm clearance will be provided throughout the spaces as a barrier-free path of travel. All tables will be as per OADS. The party room kitchen will have a counter set at 860mm (34' tall), with a sink.

Each floor will have a garbage chute room with barrier-free access. A PDO to be provided on the corridor side with a hold-open timer allowing occupant to drop-off waste while door remains open avoiding entrapment.

Acoustics: Acoustics will be as per acoustic report and will meet OADS requirements

E. Common Facility Areas – Accessible Washroom

Reference: Oshawa Accessibility Design Standards (OADS) 4.5; 4.6 Pages 101-115, 117-120

Accessible Washrooms will be provided:

- a) One accessible washroom will be provided in the lobby. The ground floor washroom will be fully OADS compliant and will include a toilet and sink.
- b) One accessible washroom will be provided in at level 2. The second-floor washroom will be fully OADS compliant and will include a toilet and sink.
- c) One accessible washroom will be provided at level 6. The sixth-floor washroom will be fully OADS compliant and will include a toilet and sink.
- d) One universal washroom will be provided at level 18 The eighteenth-floor washroom will be designed as a universal washroom and include an adult change table. Emergency call system to be provided. All washroom fixtures/features to be in compliance with OADS.

Turning Radius: Universal Washroom – 1700mm. Accessible washrooms – 1500mm

Power Door Operators: Power door hardware will be provided for all accessible washrooms.

Emergency Alert System: As per OADS requirements in universal washrooms

Grab Bars: As per OADS requirements

Placement of Items: As per OADS requirements

F. Common Facility Floor Surfaces, Colour Contrast

Reference: Oshawa Accessibility Design Standards (OADS) 2.1; 4.3; 5.6 Page 17-20, 93-96, 135-138

OADS Requirements

Meets Standards

Explain: As per OADS requirements. The vestibule and lobby are to utilize slipresistant tiles. The corridors are to utilize carpet as per OADS. Both spaces will utilize pronounced color contrast between floors and walls to assist a person with a visual impairment.

G. Common Facility Areas – Signage

Reference: Oshawa Accessibility Design Standards (OADS) 5.8; Pages 143-148

Signage Type (i.e. directional; tv/party room, washroom): Common areas will have signage posted outside the rooms, mounted beside doorways and at a height between 1200mm and 1500mm as per OADS. Signs should be posted on the same side of the door as the accessible door buttons.

Features (i.e. tactile, Braille, size, font, contrast): Sans Serif Arabic numbers will conform to the design standards and intent of OADS including tactile, Braille, and color contrast and raised fonts.

H. Common Facility Areas - Visual and Audible Emergency Alarms Reference: Oshawa Accessibility Design Standards (OADS) 5.6; Pages 135-138

Locations: Visual alarms, in addition to the audible alarm requirements, shall be

provided in all common corridors, the lobby, amenities and the stairways. The alarms shall conform to the OADS design requirements.

Features: As per design requirements.

I. Common Facility Lighting

Reference: Oshawa Accessibility Design Standards (OADS) 5.7 Pages 139-141

Locations: Lighting in common areas (hallways, parking garages, lobby, amenities and back of house) will be selected based to meet OADS requirements.

Features: Lighting will be selected to minimize direct glare on reflective surfaces. Controls and operation mechanisms shall be as per OADS. Lighting levels as per OADS recommendations.

J. Elevator, Stairs

Reference: Oshawa Accessibility Design Standards (OADS) 2.3; 4.4 Pages 27-32

Accessible Features: All elevators are accessible via barrier free corridors (1.6m width) and elevator lobby (1.8m width). Buttons, controls, finishes and signage for elevator to be to OADS. All controls (external at each floor and internally) will be provided between 890-1200mm from the floor and have audio call-outs and braille adjacent to buttons as per OADS. All proposed stairs are to be designed as exit stairs (and not open communication stairs). However, detectable warning surfaces will be provided at each landing, no open risers will be provided, and any nosing will meet OADS requirements. Guardrails and handrails will be installed as per OBC requirements

Dimensions: Elevator cabs: 1.4m X 2.0m. There is no interior stairs in hallways or common space areas.

K. Emergency Exits, Fire Evacuation and Areas of Refuge Assistance Reference: Oshawa Accessibility Design Standards (OADS) 5.6 Pages 135-138

Fire Evacuation: As per OBC requirements, the building is to have a full sprinkler system and units are fire separated. There will be a designated firefighter elevator. Fire safety and evacuation plans will be provided as per OADS in the building. The alarm system will be as per OBC requirements.

Areas of Refuge Assistance: No distinct areas of refuge provided.

Explain: In the event of a fire, someone with accessible needs would wait in their unit. All accessible units would be marked on an evacuation plan so that firefighters can assist with evacuation from these units in the event of an emergency as per the approved fire plan.

L. Accessible Suite/Bedroom – Visual and Audible Emergency Alarms

Reference: Oshawa Accessibility Design Standards (OADS) 5.6; Pages 135-138

Locations: Visual alarms will be provided in all units on all levels. Audible Emergency Alarms will be located in each unit as designed by the Building Fire Warning System. Visual and audible alarms will be placed centrally in the main living spaces. This applied to ALL units. Additional visual & audible alarms will be provided in all accessible bedrooms.

Features: Visual and Audible Emergency Alarms devices will meet OBC and OADS requirements.

M. Accessible Suite – Suite Guest Notification System

Reference: Oshawa Accessibility Design Standards (OADS) 5.1; 5.2; 5.3; 5.5 Pages 123-125, 127-128, 129-130

Accessible features of Guest/Suite Notification System (i.e. audio, visual, Braille): Controls and required audio and visual system meet OBC and OADS requirements.

Explain: There is an audible and visual system in place from the main door and the individual suites to notify residents if they have a guest present. This will be in place for both residents and guests with hearing or vision disabilities. This assumes the resident has a compatible cellular device.

N. Accessible Suite - Signage

Reference: Oshawa Accessibility Design Standards (OADS) 5.8; Pages 143-148

Location: All suites will have identification signage outside their suite doors.

Features (i.e. tactile, Braille, size, font, contrast): Signs will be both in colour contrasting, large font letters, raised fonts and braille that will meet the OADS standards/ requirements.

O. Accessible Suite Lighting

Reference: Oshawa Accessibility Design Standards (OADS) 5.7 Pages 139-141

Locations: All rooms and spaces inside the suites.

Features: Lighting design meets OADS requirements. In-suite lighting will be selected to minimize direct glare on reflective surfaces. Light spectrum will be considered inside accessible suites, with incandescent lights

P. Accessible Suite - Floor Surfaces, Colour Contrast

Reference: Oshawa Accessibility Design Standards (OADS) 2.1; 4.3 Pages17-20, 93-96

OADS Requirements

Meets Standards

Suite flooring will be slip resistant floor finish throughout. Bathrooms will be tiled.

Q. Accessible Suites - Kitchen, Living Room, Laundry

Reference: Oshawa Accessibility Design Standards (OADS) 2.10; 4.3; 5.1; 6.5 Pages 49-51, 93-96; 123-125, 165-172

Dimensions: See Page AS251 or OADS presentation page 22 for the 3 upgraded barrier-free units, these are our 3 3-bedroom Suites.

Suite Power Door Operators: Pre wiring for the suite entry power door operators will be provided for all the barrier free suites. We will provide power doors at no cost to the tenants requiring accommodation upon written request. The three (3) fully barrier free units we will provide with power door operators.

Cupboard/Counter Height: Cupboards/counters will be installed at standard height for the barrier-free suites. The three fully barrier-free suites will have all cupboards/counters installed as per the OADS requirements.

Clearances (i.e. under sink, at counters): Sink and counters will be installed at standard heights for all the barrier-free suites. The three fully accessible suites will have the sinks and counters installed as per the OADS requirements.

Appliance Accessible Features: All barrier-free suites will have the standard appliance package. The three fully barrier-free suites will all be the ADA approved appliances. Consideration to be given to providing ADA appliances in other accessible suites upon written request.

Path of Travel: 1100MM

Electric Outlet Height: As per OADS requirements.

R. Accessible Suites – Accessible Bedroom

Reference: Oshawa Accessibility Design Standards (OADS) 2.10; 4.3; 5.1; 5.6 Pages 49-51, 93-96, 123-125,135-138

Room Dimensions: See attached drawings for dimensions.

Design and height of furniture: Furniture is for reference/display purposes only and furnishings will not be provided by the developer. Final furnishings by the tenant(s). Closets will meet the OADS requirements.

Lift adaptability: Not applicable.

Accessible Door Access: We propose 860MM clear width doors (exceed OBC standards) to access bedrooms on all accessible units. This will ensure adequate access to each bedroom and still allow for privacy if desired.

Electric Outlet Height: Meets OADS requirments

Path of Travel: 1100 mm

Compatible communication (i.e. telephone, computer) if supplied: Units will be connected to the smart home and common building vestibule phone system. As the units are accessed from a secure corridor, random visitors will not be able to visit each suite but instead will have to traverse the ground floor entry and announce themselves through the lobby call system, connected to the suites.

S. Accessible Suites – Accessible Washroom

Reference: Oshawa Accessibility Design Standards (OADS) 2.1; 4.2; 4.3; 4.5; 5.1; 5.6; 5.7 Pages

Turning Radius: A 1500mm turning radius is proposed to at least one washroom in all accessible suites. This standard meets the OBC & CSA standard. In the three upgraded barrier-free washrooms this increased to 1700mm.

Accessible Door Access: A 965mm clear door opening is to be provided to access at least one washroom in all accessible suites. The three (3) fully barrier free units we will be provided with power door operators for the accessible washroom.

Emergency Alert System: No emergency alert systems are proposed. The project team recommends personal safety devices.

Grab Bars: Accessible units will have grab bar supports blocked in during construction for future grab bar installation and they will be installed at no cost upon written request from the tenant. Washrooms in accessible units meet the general OBC (3.8) requirements. We will provide grab bars for the three fully upgraded barrier-free suites.

Accessible bathing feature (roll in shower or tub): Blocking will be installed during construction for the future installation of grab bars in shower or tub areas. The grab bars will be installed at no cost in the barrier-free units upon a written request from the tenant. There will be only 3 roll-in showers inside the 3 fully upgraded barrier-free units in this project.

Non slip flooring: Meets OADS requirements. The flooring will be non-slip tile in all the bathrooms within the entire building and will include the accessible bathroom units as well.

Placement of Items: As per attached drawings & OADS.

T. Commercial Units

Reference: Oshawa Accessibility Design Standards (OADS) 4.4.2; 4.4.16; 4.4.15; 4.4.16 Pages 66, 80-82

Power Door Operators: Power door operators will be provided to commercial suites

Access to Multi-levels: No multi-levels are planned.

Additional Information

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<u>OWNER</u>

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<u>PLANNING</u>

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STRUCTURAL Thornton Tomasetti 116 Spadina Ave, Suite 301, Toronto, ON M5V 2K6 (416) 306-8112

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June 11, 2025

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WASTE MANAGEMENT **Cini-Little** 2300 Yonge St, Suite 1600,

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ARCHAEOLOGICAL

AS&G Archaeological Consulting 34 Leith Hill Rd #805 Toronto, ON M2J 1Z4 (647) 680-3280

ELEVATOR

Soberman Engineering Inc. 60 St. Clair Avenue East, Suite 806, Toronto, ON M4T 1N5 (416) 323-2133

SHORING

BUILDING CODE Jensen Hughes

2680 Skymark Avenue, Suite 411, Mississauga, ON L4W 5L6 (416) 762-3808

DRAWING NOT TO BE SCALED

Contractor must check and verify all dimensions on the job and report any discrepancies to the architect before proceeding with the work.

This drawing shall not be used for construction purposes until signed by the consultant responsible. This drawing, as an instrument of service, is provided by and is the property of Sweeny & Co. Architects

yy-mm-dd	ISSUED / REVISED
24-05-24	For SPA
24-08-29	For SPA
25-06-11	For Accessibility Committee

City Centre Residences

39 Athol Street W, Oshawa, ON

Issued for ACCESSIBILITY **COMMITTEE REVIEW**

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PROJ. NAME City Centre Residences 39 Athol Street W, Oshawa ON

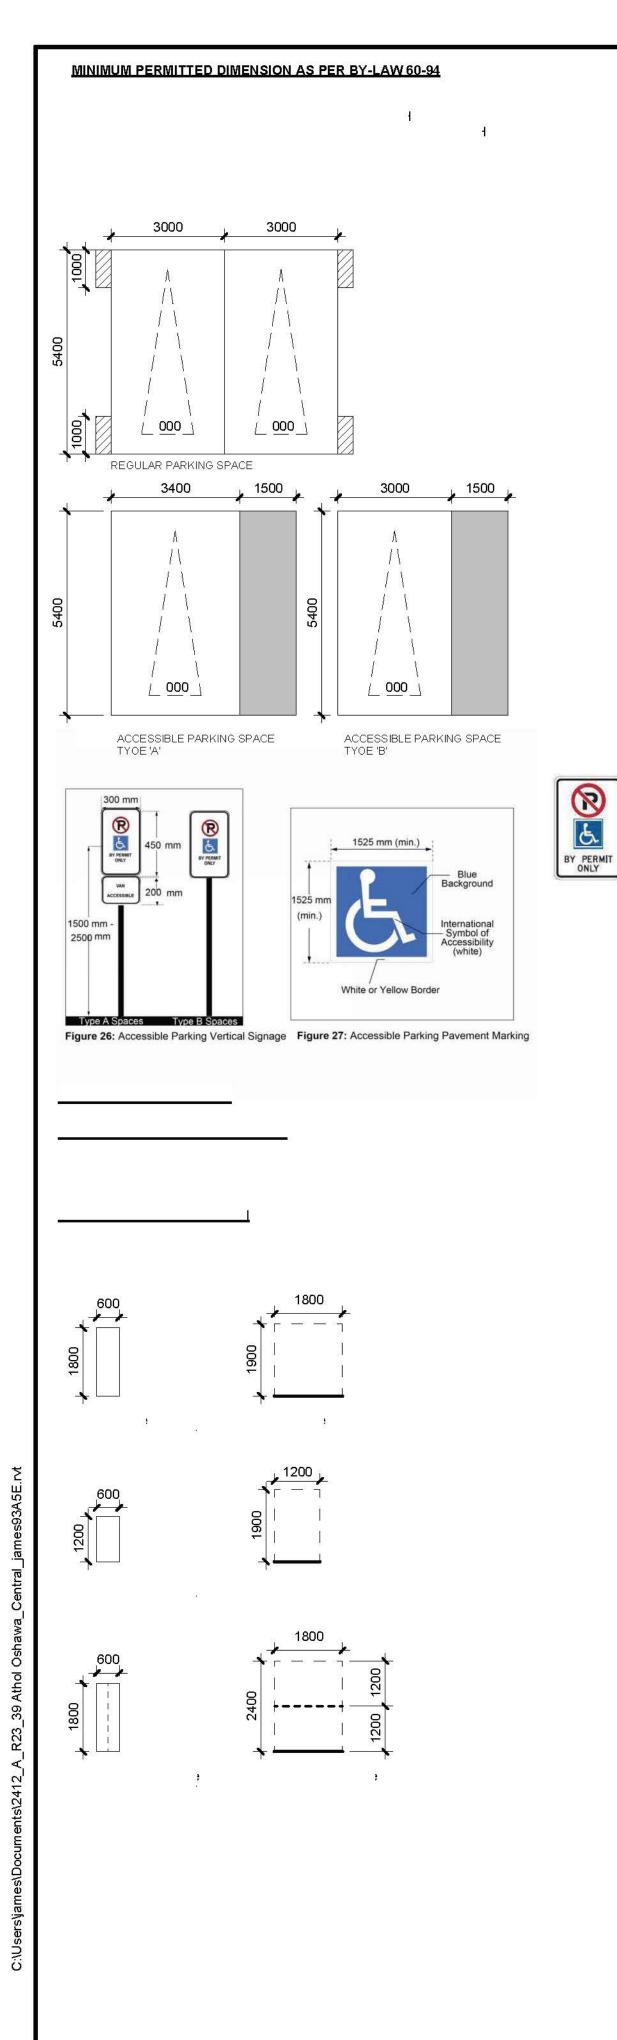


owner Central Clear View Developments Inc.

DWG TITLE Cover Page

2024-08-29 DATE: SCALE : DRAWN : HK CHECKED : HS PROJ. No. : 2412

DWG No. **AS000**



		ZONING REQU	IREMENTS
SITE			
GROSS SITE AREA	NOTES		
NET SITE AREA	-		
COVERACE			
COVERAGE			
TYPE	NOTES		
BUILDING COVERAGE* PAVED AREA*	*percentage of NE	T SITE AREA	
LANDSCAPING*			
NET SITE AREA			
FSI			
-51			
ТҮРЕ	NOTES		
TOTAL RES GFA TOTAL RETAIL GFA			
TOTAL GFA			
RESIDENTIAL AMENITY			
TYPE		REQUIRED	REQU
The second s		(m²/unit)	
INDOOR OUTDOOR	204 units 204 units		-
TOTAL RES. AMENITY	-	4	.00
VEHICULAR PARKING			
VEHICOLAR PARKING			
TYPE			PROPOSED
Residential Residential Visitor	204 units 204 units	C	0.62 spaces 0 spaces
Retail	139.26 m ²		0 per 100
TOTAL PARKING			
LEVEL	RESIDENT	TANDEM	
P1	32		4
L1	5		0
L2 L3	17 22		0
L4	22		0
L5 TOTAL PARKING			0 4
*Accessible parking spaces & EV Ro		al	<u> </u>
BICYCLE PARKING			
TYPE			REC
Res LONG TERM Res SHORT TERM	204 units 204 units	C	0.68 spaces 0.1 spaces
TOTAL BICYCLES		2	orr options
	DECLT	DEC OT	
LEVEL BREAKDOWN	<u>RES. LT.</u> 0	RES. ST.	12
L1 - Interior	118		10
TOTAL BICYCLES	118		22
LOADING & STAGING			
and a set		1	
Type G		F	REQUIRED
Туре С			
STAGING			
NOTE - Private waste haulers for was NOTE - Loading space is combined T		nagement Report	
GARBAGE ROOM	, , , , , , , , , , , , , , , , , , ,		
	-1		FOUNDED
TYPE BUILDING		h	REQUIRED
BULKY			
RETAIL		-	
TOTAL GARBAGE NOTE - Refer to Waste Management I	Report for full details & calcul	ations.	
		TFA	
		in the second	
NDERGROUND ARKING		Area m ²	Area S
Level -1		562.35 m ²	6,053 5
ARKING TOTAL		562.35 m ² 562.35 m ²	6,053 S 6,053 S
	,	1.0	
		TFA	
BOVE GRADE		Area m ²	Area S
ODIUM Level 01		1,768.68 m ²	19,038 \$
Level 02 Level 03		1,600.88 m ² 1,652.59 m ²	17,232 S
Level 04		1,652.55 m ²	17,788 \$
oval 05		1 653 36 m ²	17 797 9

1

1

EQUIRED (m²

0.62 spaces/unit =

0 spaces/unit = 0 per 100.00 m² =

BF

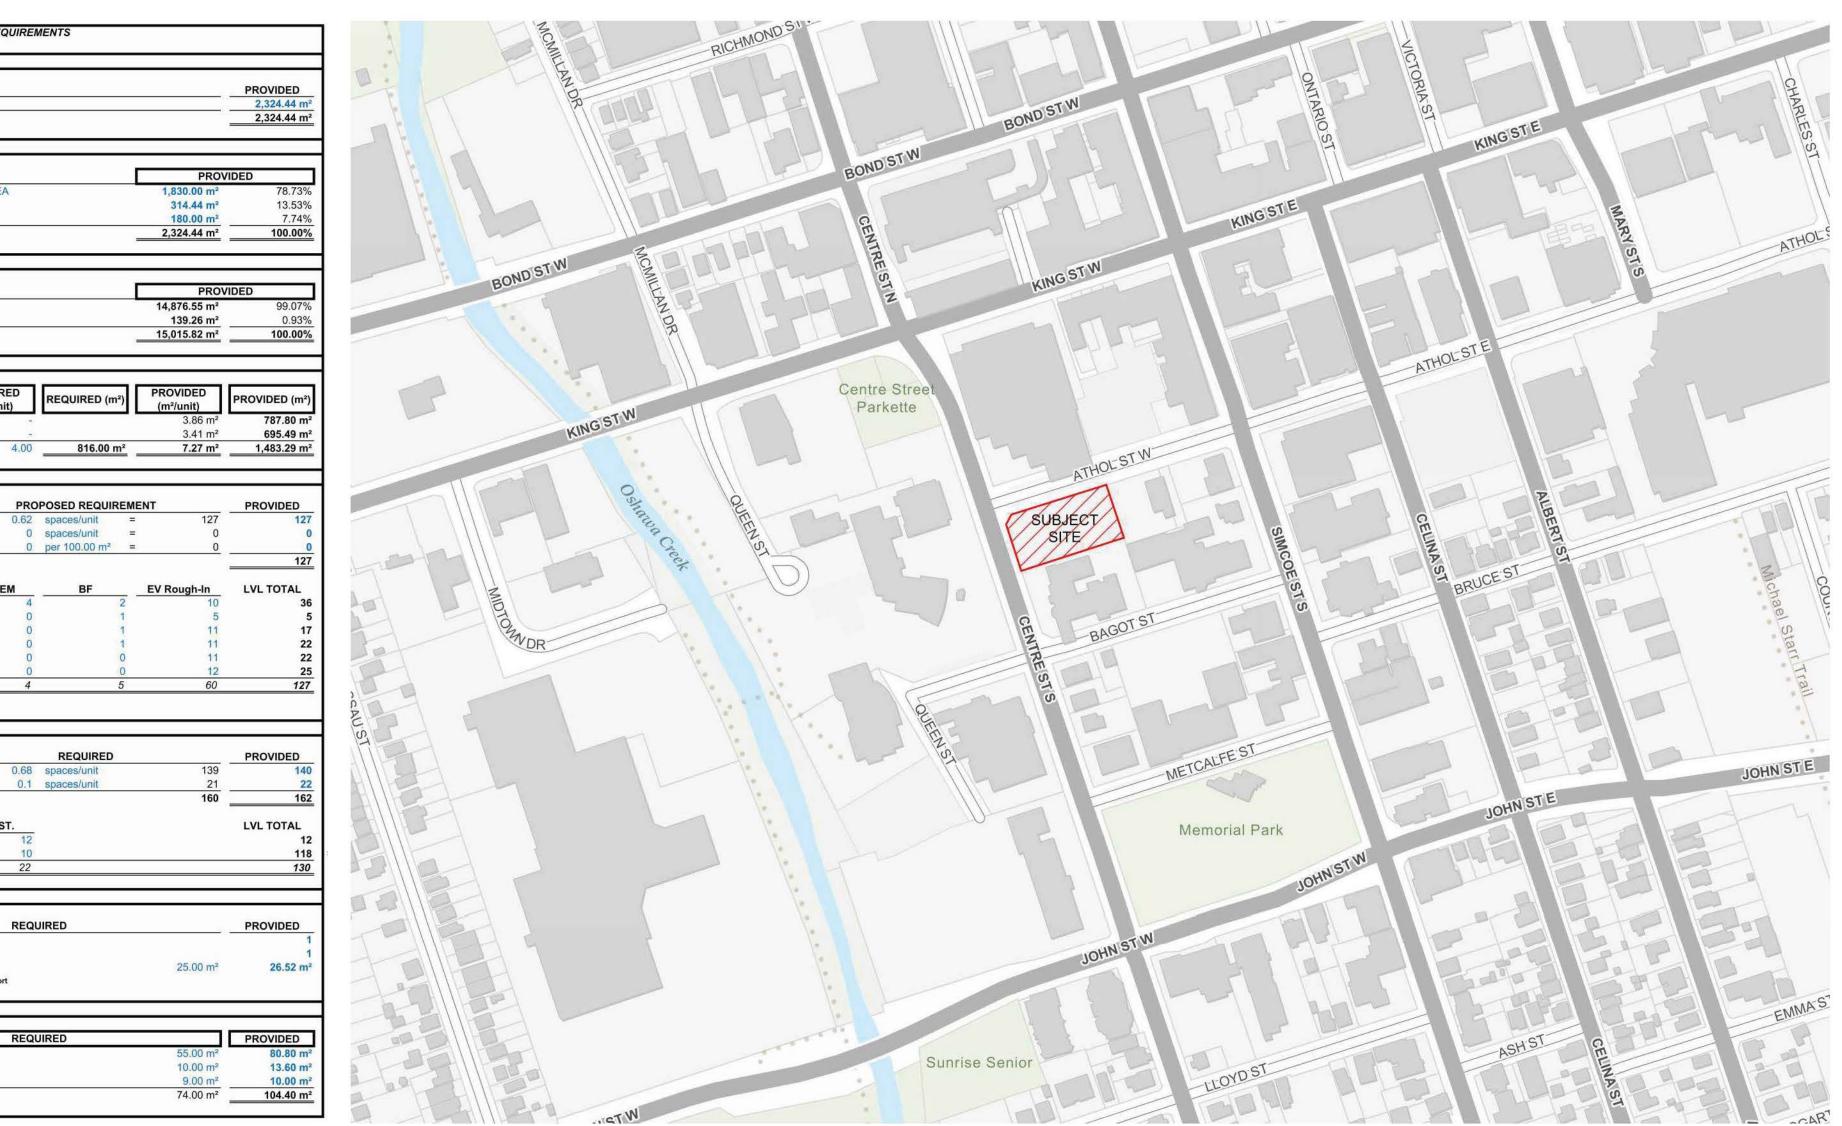
 REQUIRED

 0.68
 spaces/unit

 0.1
 spaces/unit

				-	-						-50			
TYPE		REQUIRED		PROVIDED	0	P-211				1	- · ·			2
BUILDING			55.00 m	² 80.80 n	12	1	THAT					0		at an Real
BULKY			10.00 m	13.60 m	1 ²	THE THE	TATA					0	unrise Sei	mor
RETAIL			9.00 m	10.00 n	1 ²	OF 241								-
TOTAL GARBAGE			74.00 m	104.40 m	1 ²	HU					9			THI
NOTE - Refer to Waste Management Report f	or full details & calculations.					1th	112-00	TPIL	N					
	TFA	Ĩ	TFA + OTH	ER				GFA	A (City of Oshawa By	y-law 60-94)				
N					RESIDEN	NTIAL	RETAI	L	GFA TO	DTAL	INDOOR A		OUTDOOR	AMENITY
UNDERGROUND	Area m ²	Area SF	Area m ²	Area SF	Area m ²	Area SF	Area m ²	Area SF	Area m ²	Area SF	Area m ²	Area SF	Area m ²	Area SF
PARKING											L		r	
Level -1	562.35 m ²	6,053 SF	1,986.91 m ²	21,387 SF	40.69 m ²	438 SF	**	***	40.69 m ²	438 SF			-	
PARKING TOTAL	562.35 m²	6,053 SF	1,986.91 m²	21,387 SF	40.69 m²	438 SF			40.69 m²	438 SF				
UNDERGROUND TOTAL	562.35 m ²	6,053 SF	1,986.91 m ²	21,387 SF	40.69 m ²	438 SF	-		40.69 m ²	438 SF	-	-	1770	
	TFA		TFA + PARK	ING				GFA	A (City of Oshawa By	y-law 60-94)				
					RESIDEN	NTIAL	RETAI	L	GFA TO	DTAL	INDOOR A	MENITY	OUTDOOR /	AMENITY
ABOVE GRADE	Area m ²	Area SF	Area m ²	Area SF	Area m ²	Area SF	Area m ²	Area SF	Area m ²	Area SF	Area m ²	Area SF	Area m ²	Area SF
PODIUM														
Level 01	1,768.68 m ²	19,038 SF	1,768.68 m ²	19,038 SF	325.25 m ²	3,501 SF	98.17 m ²	1,057 SF	423.43 m ²	4,558 SF	15.80 m ²	170 SF	225.14 m ²	2,423 SF
Level 02	1,600.88 m²	17,232 SF	1,600.88 m ²	17,232 SF	425.89 m ²	4,584 SF	43.26 m ²	466 SF	469.14 m ²	5,050 SF	214.82 m ²	2,312 SF	222	
Level 03	1,652.59 m ²	17,788 SF	1,652.59 m ²	17,788 SF	497.92 m ²	5,360 SF	-	572	497.92 m ²	5,360 SF	্ৰন্থ		3365	1.55
Level 04	1,652.55 m²	17,788 SF	1,652.55 m ²	17,788 SF	484.57 m ²	5,216 SF		++.`	484.57 m ²	5,216 SF		-		
Level 05	1,653.36 m²	17,797 SF	1,653.36 m ²	17,797 SF	477.68 m ²	5,142 SF			477.68 m ²	5,142 SF	-			1/22
Level 06	1,164.80 m ²	12,538 SF	1,164.80 m ²	12,538 SF	1,097.74 m ²	11,816 SF	-		1,097.74 m ²	11,816 SF	179.85 m ²	1,936 SF	196.97 m ²	2,120 SF
SUBTOTAL	9,492.86 m²	102,180 SF	9,492.86 m²	102,180 SF	3,309.04 m²	35,618 SF	141,43 m²	1,522 SF	3,450.47 m²	37,141 SF	410.47 m ²	4,418 SF	422.11 m ²	4,544 SF
MID-RISE														
Level 07	1,048.98 m ²	11,291 SF	1,048.98 m ²	11,291 SF	996.92 m ²	10,731 SF	- <u>- 1</u>	- <u></u>	996.92 m ²	10,731 SF	1000 C	-	122	121
Level 08 to 16	9,440.82 m ²	101,620 SF	9,440.82 m ²	101,620 SF	8,972.30 m ²	96,577 SF	-		8,972.30 m ²	96,577 SF				
Level 17	1,048.36 m ²	11,284 SF	1,048,36 m ²	11,284 SF	996.95 m ²	10,731 SF			996.95 m ²	10,731 SF		1944	122	22
Level 18 (MPH & Amenity)	746.44 m ²	8,035 SF	746.44 m ²	8,035 SF	487.10 m ²	5,243 SF	-	-	487.10 m ²	5,243 SF	367.73 m ²	3,958 SF	273.37 m ²	2,943 SF
SUBTOTAL	12,284.60 m ²	132,230 SF	12,284.60 m²	132,230 SF	11,453.27 m²	123,282 SF	175		11,453.27 m²	123,282 SF	367.73 m²	3,958 SF	273.37 m ²	2,943 SF
ABOVEGRADE TOTAL	21,777.47 m ²	234,411 SF	21,777.47 m ²	234,411 SF	14,762.32 m ²	158,900 SF	141.43 m ²	1.522 SF	14.903.75 m ²	160.423 SF	778.20 m ²	8.377 SF	695.49 m ²	7.486 SF
GRAND TOTAL	22,339.82 m ²	240,464 SF	23,764.37 m ²	255,798 SF	14,762.32 m ²	159,338 SF	141.43 m ²	1,522 SF	14,944.44 m ²	160,861 SF	778.20 m ²	8,377 SF	695.49 m ²	7,486 SF
GRAND TOTAL	22,339.62 m ⁻	Contraction in the second	23,764.37 m- TFA + OTH	and a second sec	RESIDEN		RETAI		14,944.44 m ²		INDOOR A		OUTDOOR /	and the second s
	IFA		IFA + UIH	EN	RESIDER	11/16	INE I AI	he	GrA IC	JINE .	INDOORA	Without WITE T	OUTDOOR	PANIE NIT I

*** Areas in square feet are for reference only.



Level
Level -1
Level 02
Level 03
Level 04
Level 05
Total: 122

DRAWING NOT TO BE SCALED

Contractor must check and verify all dimensions on the job and report any discrepancies to the architect before proceeding with the work.

This drawing shall not be used for construction purposes until signed by the consultant responsible. This drawing, as an instrument of service, is provided

	ISSUED / REVISED
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24-08-29	For SPA
25-06-11	For Accessibility Committee
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	r	SALEABLE / R	ENTABLE		1				Т	OTAL R	ESIDEN	TIAL U	NIT CO	UNT			
	RESIDEN		RETAI	L													
-	Area m ²	Area SF	Area m ²	Area SF		BACH	18D	1BDBF	1BD+D	1BD+DBF	2BD	2BDBF	2BD+D	3BD	3BDBF	3BD+D	TOTAL
-		-	98,17 m ²	1,057 SF						-							
-				1,007 01	1 1			12		-	-	-				1	
-	377.84 m ²	4.067 SF			1	-	1	1	1		2	-	-	_	1		
-	377.75 m ²	4,066 SF				- 2	1	1	1	-	2	-	-	-	1	-	
2	377.79 m ²	4,067 SF	12	<u>11</u> 9	1		1	1	1		2	-	-	-	1	1	
F	795.99 m ²	8,568 SF			1	-	2	1	5	1	3	1	1	-	-	-	1
2	1,929.37 m²	20,768 SF	98.17 m²	1,057 SF	1		5	4	8	1	9	1	1	~	3	+	3.
+						-					-			-			
-	909.95 m ²	9,795 SF		<u>ate</u> ar	1	-	3	1	6		2	1	2	1	-	-	1
	8,189.52 m²	88,151 SF			1	-	27	9	54	-	18	9	18	9	-	-	14
-	909.51 m²	9,790 SF		22	1	1	1	1	1	-	1	1	3	1	-	3	1
#	-	-	-			-	-		-		-	-	-	-	-	-	
1	10,008.98 m²	107,736 SF	<u></u>	1		-	31	11	61		21	11	23	11		3	17
1	11,938.34 m ²	128,503 SF	98.17 m²	1,057 SF		-	36	15	69	1	30	12	24	11	3	3	20
F	11,938.34 m ²	128,503 SF	98.17 m ²	1,057 SF		0		1:	21			66)	17	l.	
	RESIDEN	ITIAL	RETAI			0.0%	17.6%	7.4%	33.8%	0.5%	14.7%	5.9%	11.8%	5.4%	1.5%	1.5%	
					AVG. UNIT SIZE PER	-	42.52 m ³ 458 SF	48.22 m ² 519 SF	51.28 m ² 552 SF	60.89 m ^a 655 SF	66.80 m ² 719 SF	67.53 m ² 727 SF	74.59 m² 803 SF	83.72 m ^a 901 SF	97,56 m ^a 1,050 SF	106.37 m ³ 1,145 SF	
					TYPE	0	400 01		6	655 ar	119.51	12/ 5/	oup ar	901 SF	3	1,145 ar	3
					BARRIER FREE	0			3%			12			18%		159
					SUITES												

Storage Locker						
Locker Type	Count					
915x1525	64					
915x1525	21					
915x1525	15					
915x1525	12					
915x1525	10					

Loud	Stall Use	Tuno	Subuse	Count
Level	Stail Use	Type		7, mar 200 200 00
Level 01	R	Stacked - 1800 x 600 mm	LONG TERM	140
LONG TERM		14 14		140
Level 01	R	Horizontal - 1800 x 600mm	SHORT TERM	12
Level 01	R	Vertical - 1200 x 600 mm	SHORT TERM	10
SHORT TERM		24		22
Total				162

Parking Totals							
Level	Stall Use	Subuse	Barrier Free	Count			
Level -1	RESIDENT		2	31			
Level -1	RESIDENT	Tandem	0	4			
Level 01	RESIDENT		1	5			
Level 02	RESIDENT		1	17			
Level 03	RESIDENT		1	22			
Level 04	RESIDENT		0	23			
Level 05	RESIDENT		0	25			
Total	- 30		5	127			

Level -1 RESIDENT 1 Type A Level 01 RESIDENT 1 Type A	
Level 01 RESIDENT 1 Type A	
Type A 2	
Level -1 RESIDENT 1 Type B	
Level 02 RESIDENT 1 Type B	
Level 03 RESIDENT 1 Type B	
Level 02 RESIDENT 1 Type B	



134 PETER STREET | SUITE 1601 TORONTO, ONTARIO | M5V 2H2 | CANADA P: 416-971-6252 | F: 416-971-5420 E: info@sweenyandco.com | www.sweenyandco.com

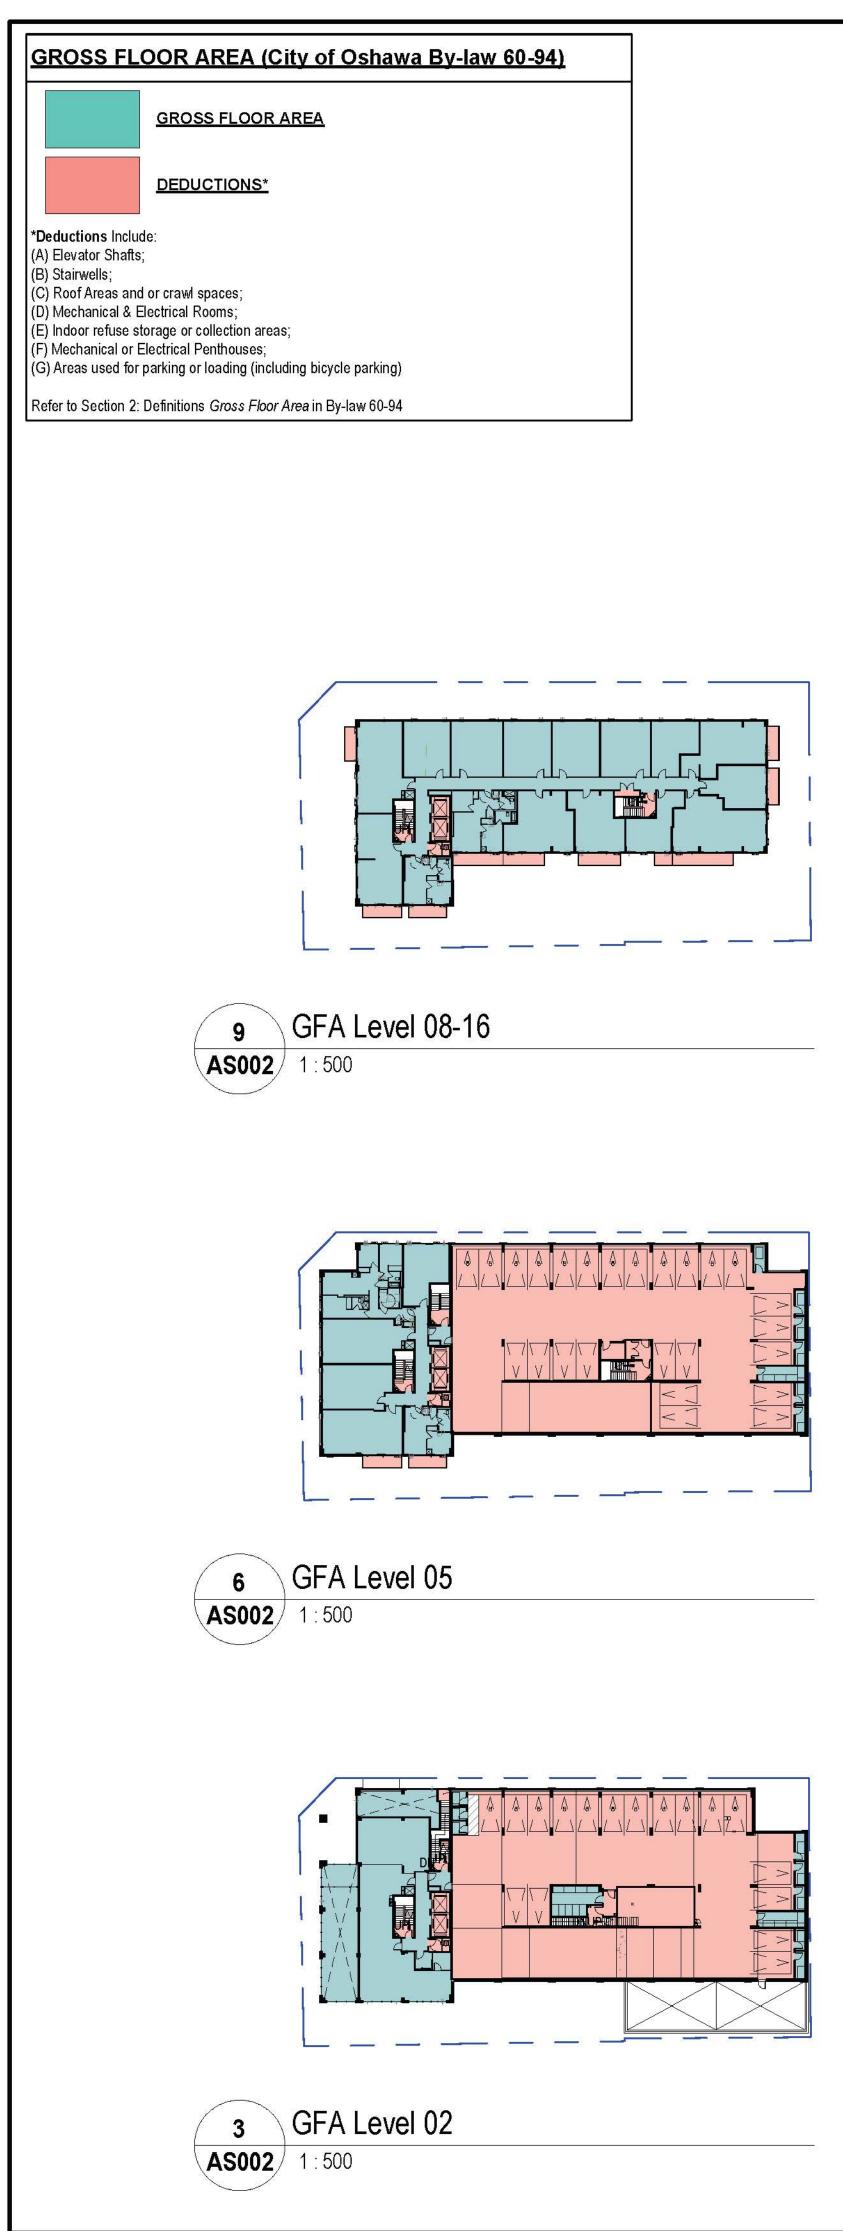
PROJ. NAME City Centre Residences 39 Athol Street W, Oshawa ON

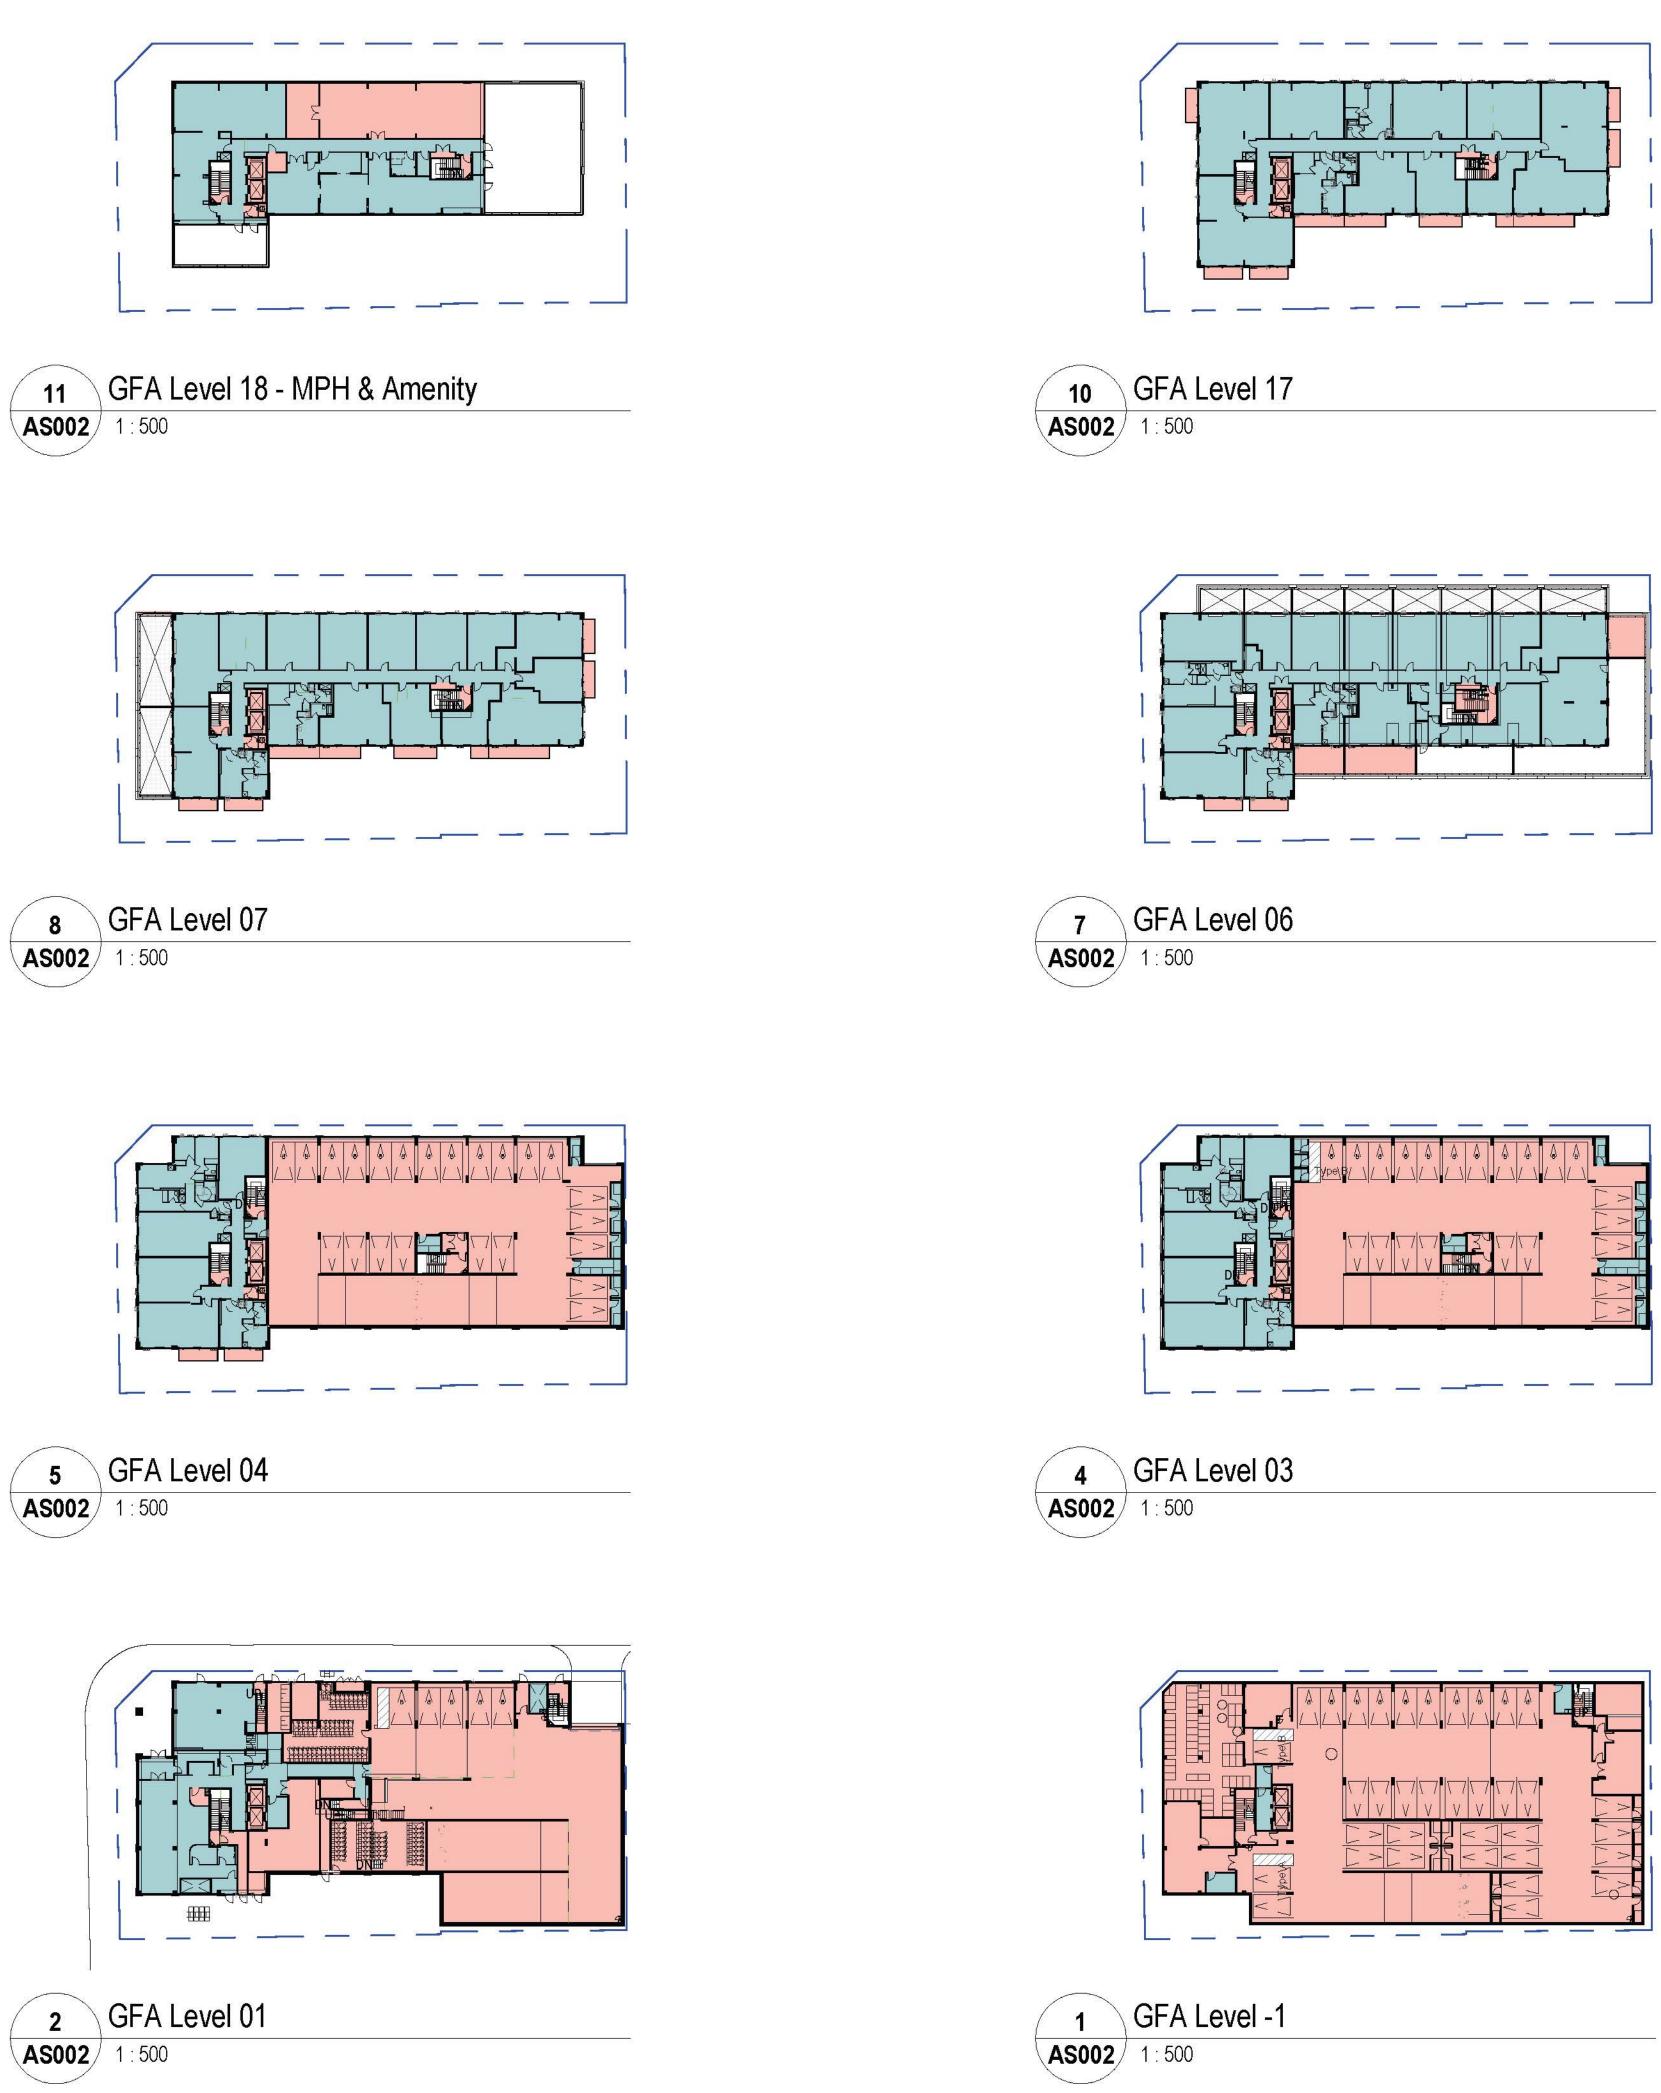


owner Central Clear View Developments Inc.

DWG TITLE Context Plan & Project Statistics

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НК	
HS	
2412	DWG No.
	AS001
	НК НS 2412





the job and re bef	ust check and verify all dimensions on eport any discrepancies to the architect ore proceeding with the work. ng shall not be used for construction
This drawing,	il signed by the consultant responsible. as an instrument of service, is provided property of Sweeny & Co. Architects. ISSUED / REVISED
24-05-24 24-08-29	For SPA For SPA
25-06-11	For Accessibility Committee
	eny&Co hitects
P: 416-971-62	TREET SUITE 1601 NTARIO M5V 2H2 CANADA 52 F: 416-971-5420 nyandco.com www.sweenyandco.com
· · · · · · · · · · · · · · · · · · ·	ntre Residences eet W, Oshawa ON
OWNER	CITY CENTRE Residences
	Clear View oments Inc.
dwg tiπ∟e GFA Dia	agrams

DATE:	2024-08-29
SCALE :	As indicated
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CHECKED :	HS
PROJ. No. :	2412

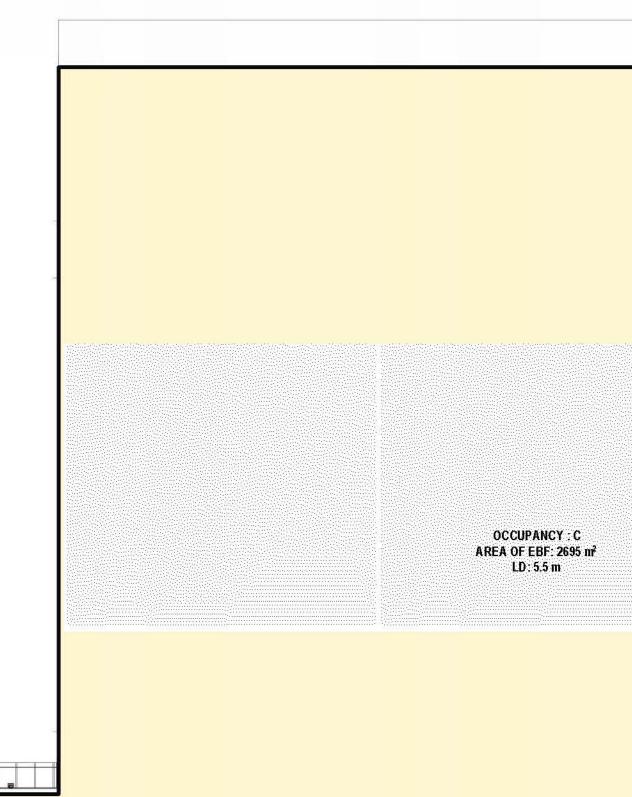
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AS002

170700 MAX BUILDING HEIGHT

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155600 Level 16				
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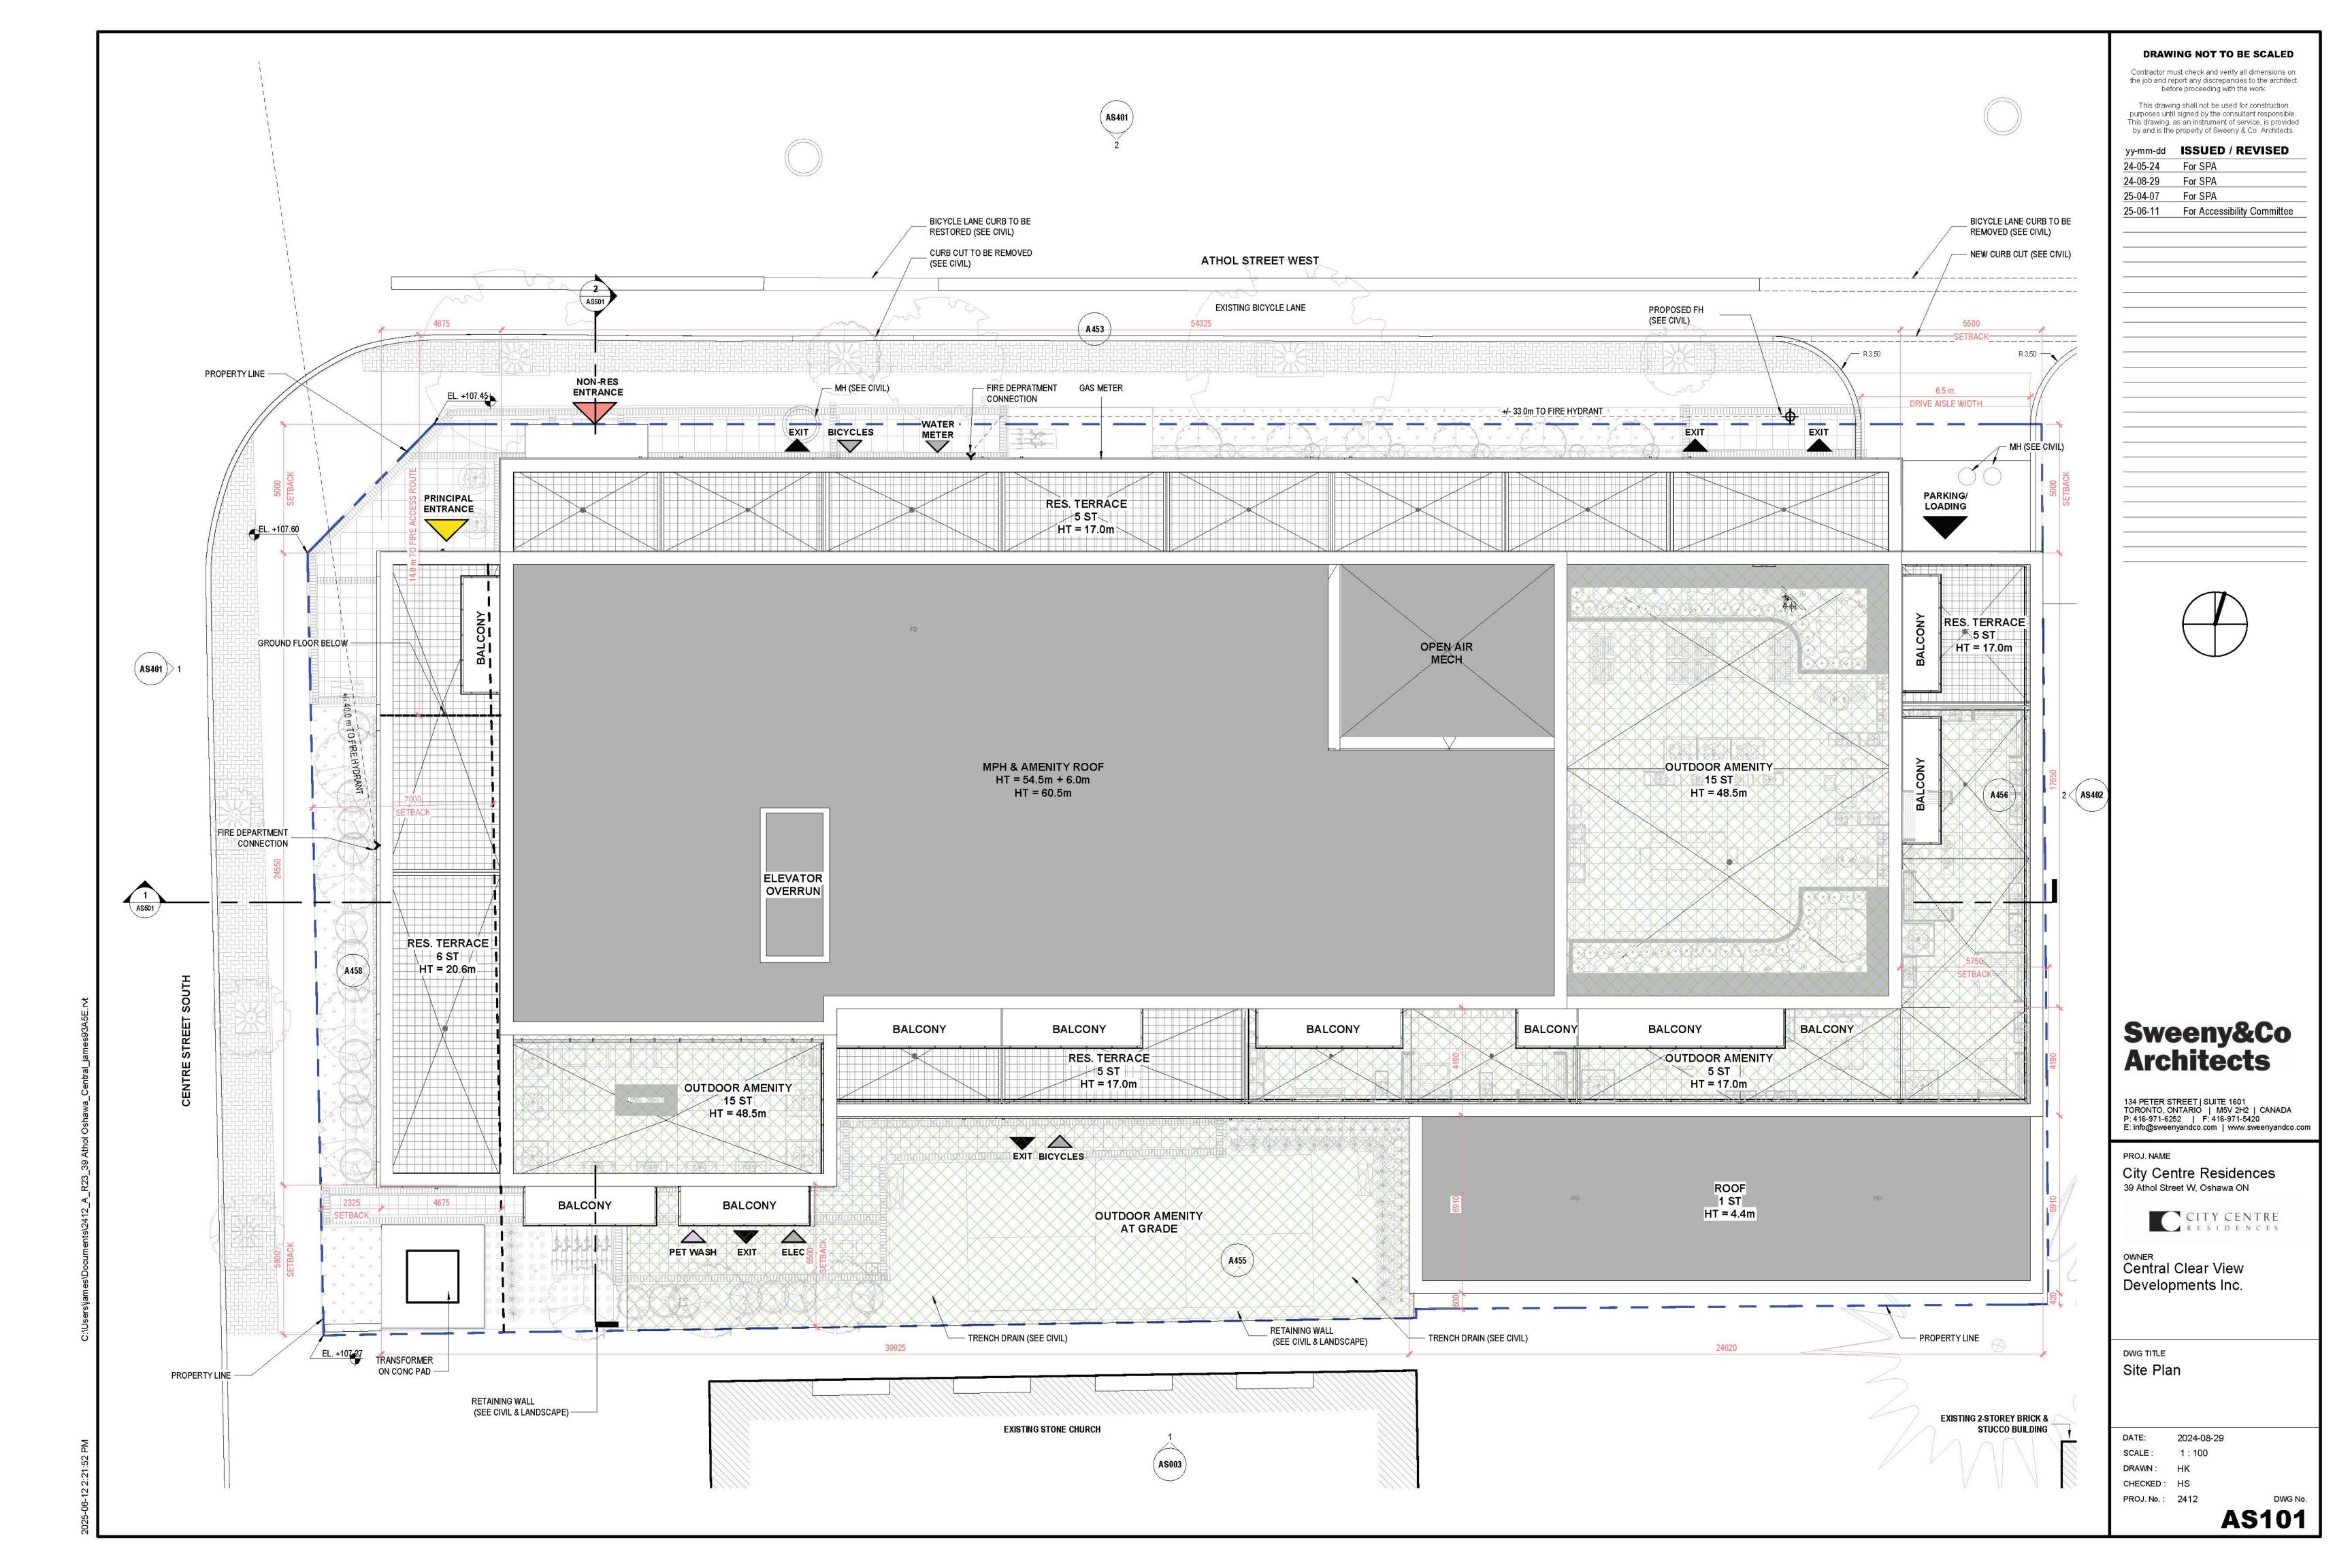
Spatial Separation – Construction of Exterior Walls

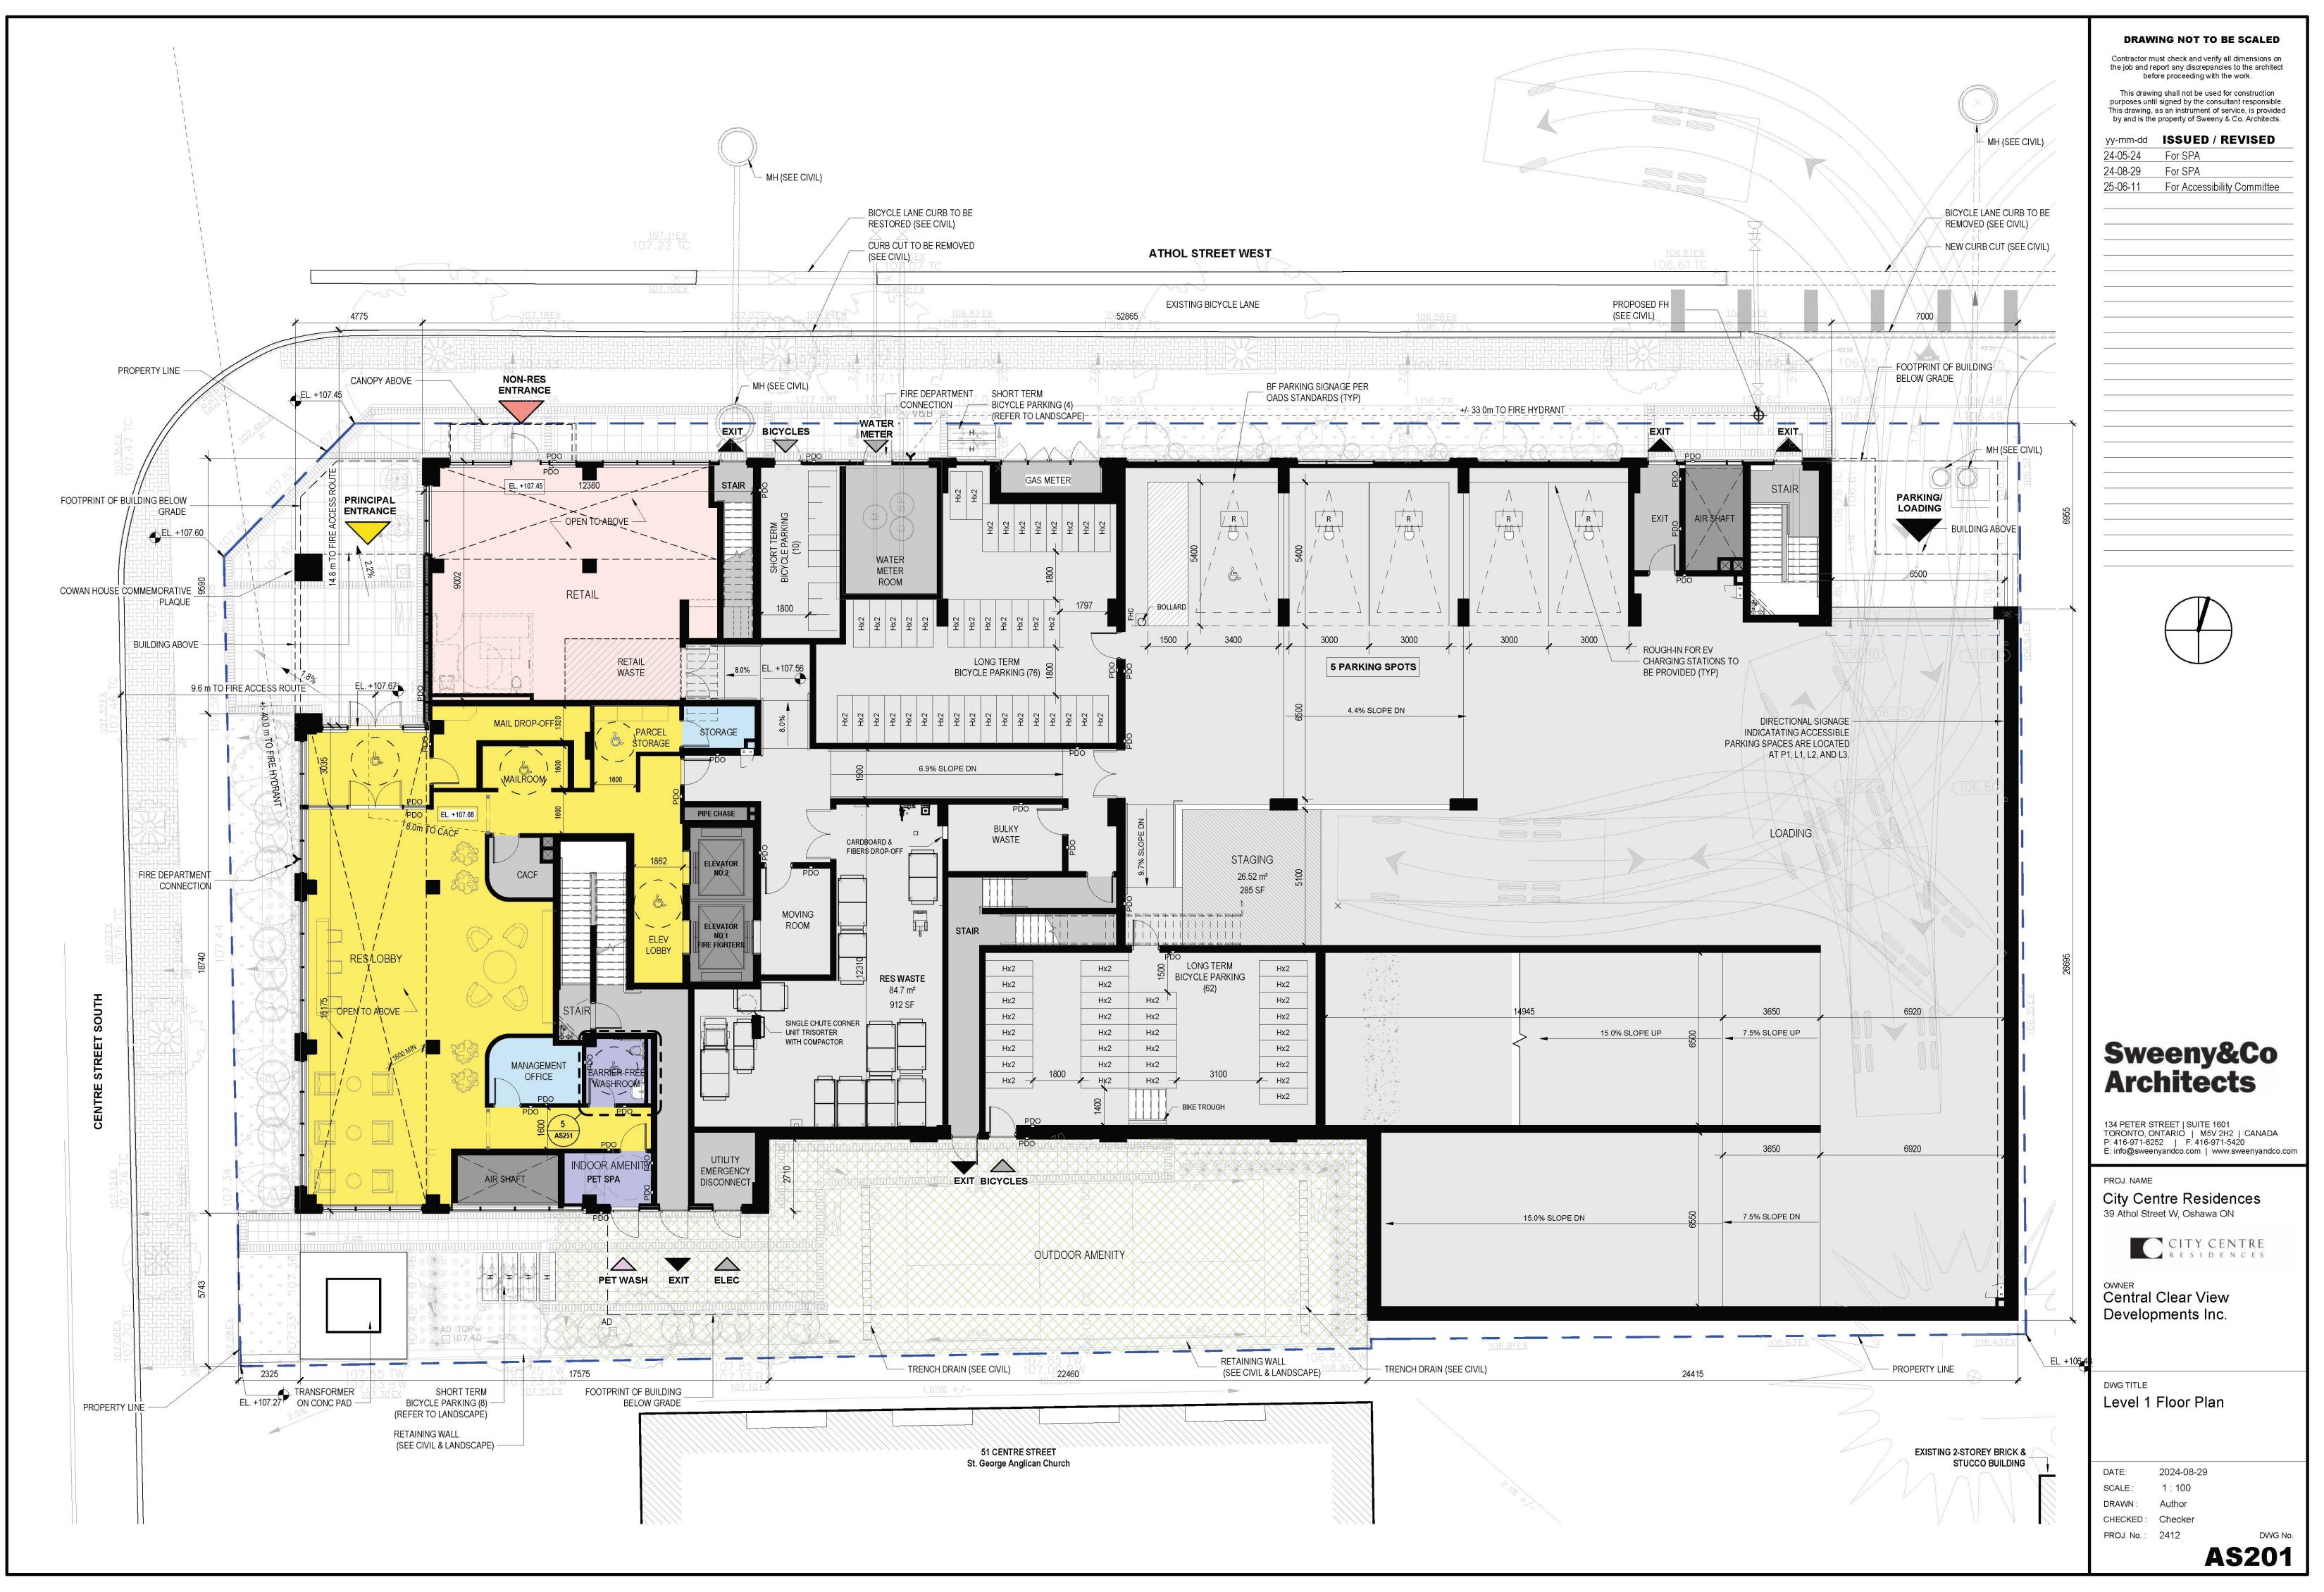
Wall	Occupancy	Area of EBF (m2)	L.D. (m)	L/H (m)	Permitted % of Unprotected Openings	Proposed % of Unprotected Openings	F
NORTH	varies	2	≥9.0	-	100	100	
SOUTH				15			
Level 1	F3	98	0	40/4	0	0	4
Level 2-5	F3	605	7.0	18/13	66	66	4
Levels 1-16	с	2695	5.5	54.5/43.5	46	46	1
EAST							+
Level 1-5	F3	495	0	32.5 /18	0	0	-
Level 2-16	с	1063	5.5	24.5/56.5	46	46	1
WEST	varies		≥9.0	-	100	100	-

Note 1: If applicable, foam plastic insulation used in an exterior wall shall be protected on its exterior s Min. 25mm thick concrete/masonry cladding per OBC 3.2.3.8. Non-combustible cladding material meeting ULC-S101 per OBC 3.2.3.8.



FRR (hr)	Listed Design or Description	Const	uction Type		
4	4	1 1 1 1 1 1			
	Precast concrete panel cladding (1HR FRR metal stud wall backup per OBC SB-2 2.3.4.A. (Also see Note 1)		ombustible construction and non- istible cladding per OBC 3.2.3.7		
1	Window wall system (1HR FRR shaft wall UL W452) Prefinished metal panel (1HR FRR metal stud wall backup UL W424)			<u>20-1</u>	
1					
	Precast concrete panel cladding (1HR FRR metal stud wall backup per OBC SB-2 2.3.4.A. (Also see Note 1)		ombustible construction and non- stible cladding per OBC 3.2.3.7		
1	Window wall system (1HR FRR shaft wall UL W452) Prefinished metal panel (1HR FRR metal stud wall backup UL W424)			1 <u>4</u>	
	-	-		(1997) 1997)	
surface by					2mg Shadhadhadhar
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				997 <u>-00</u> 67.50 <u>096</u>	
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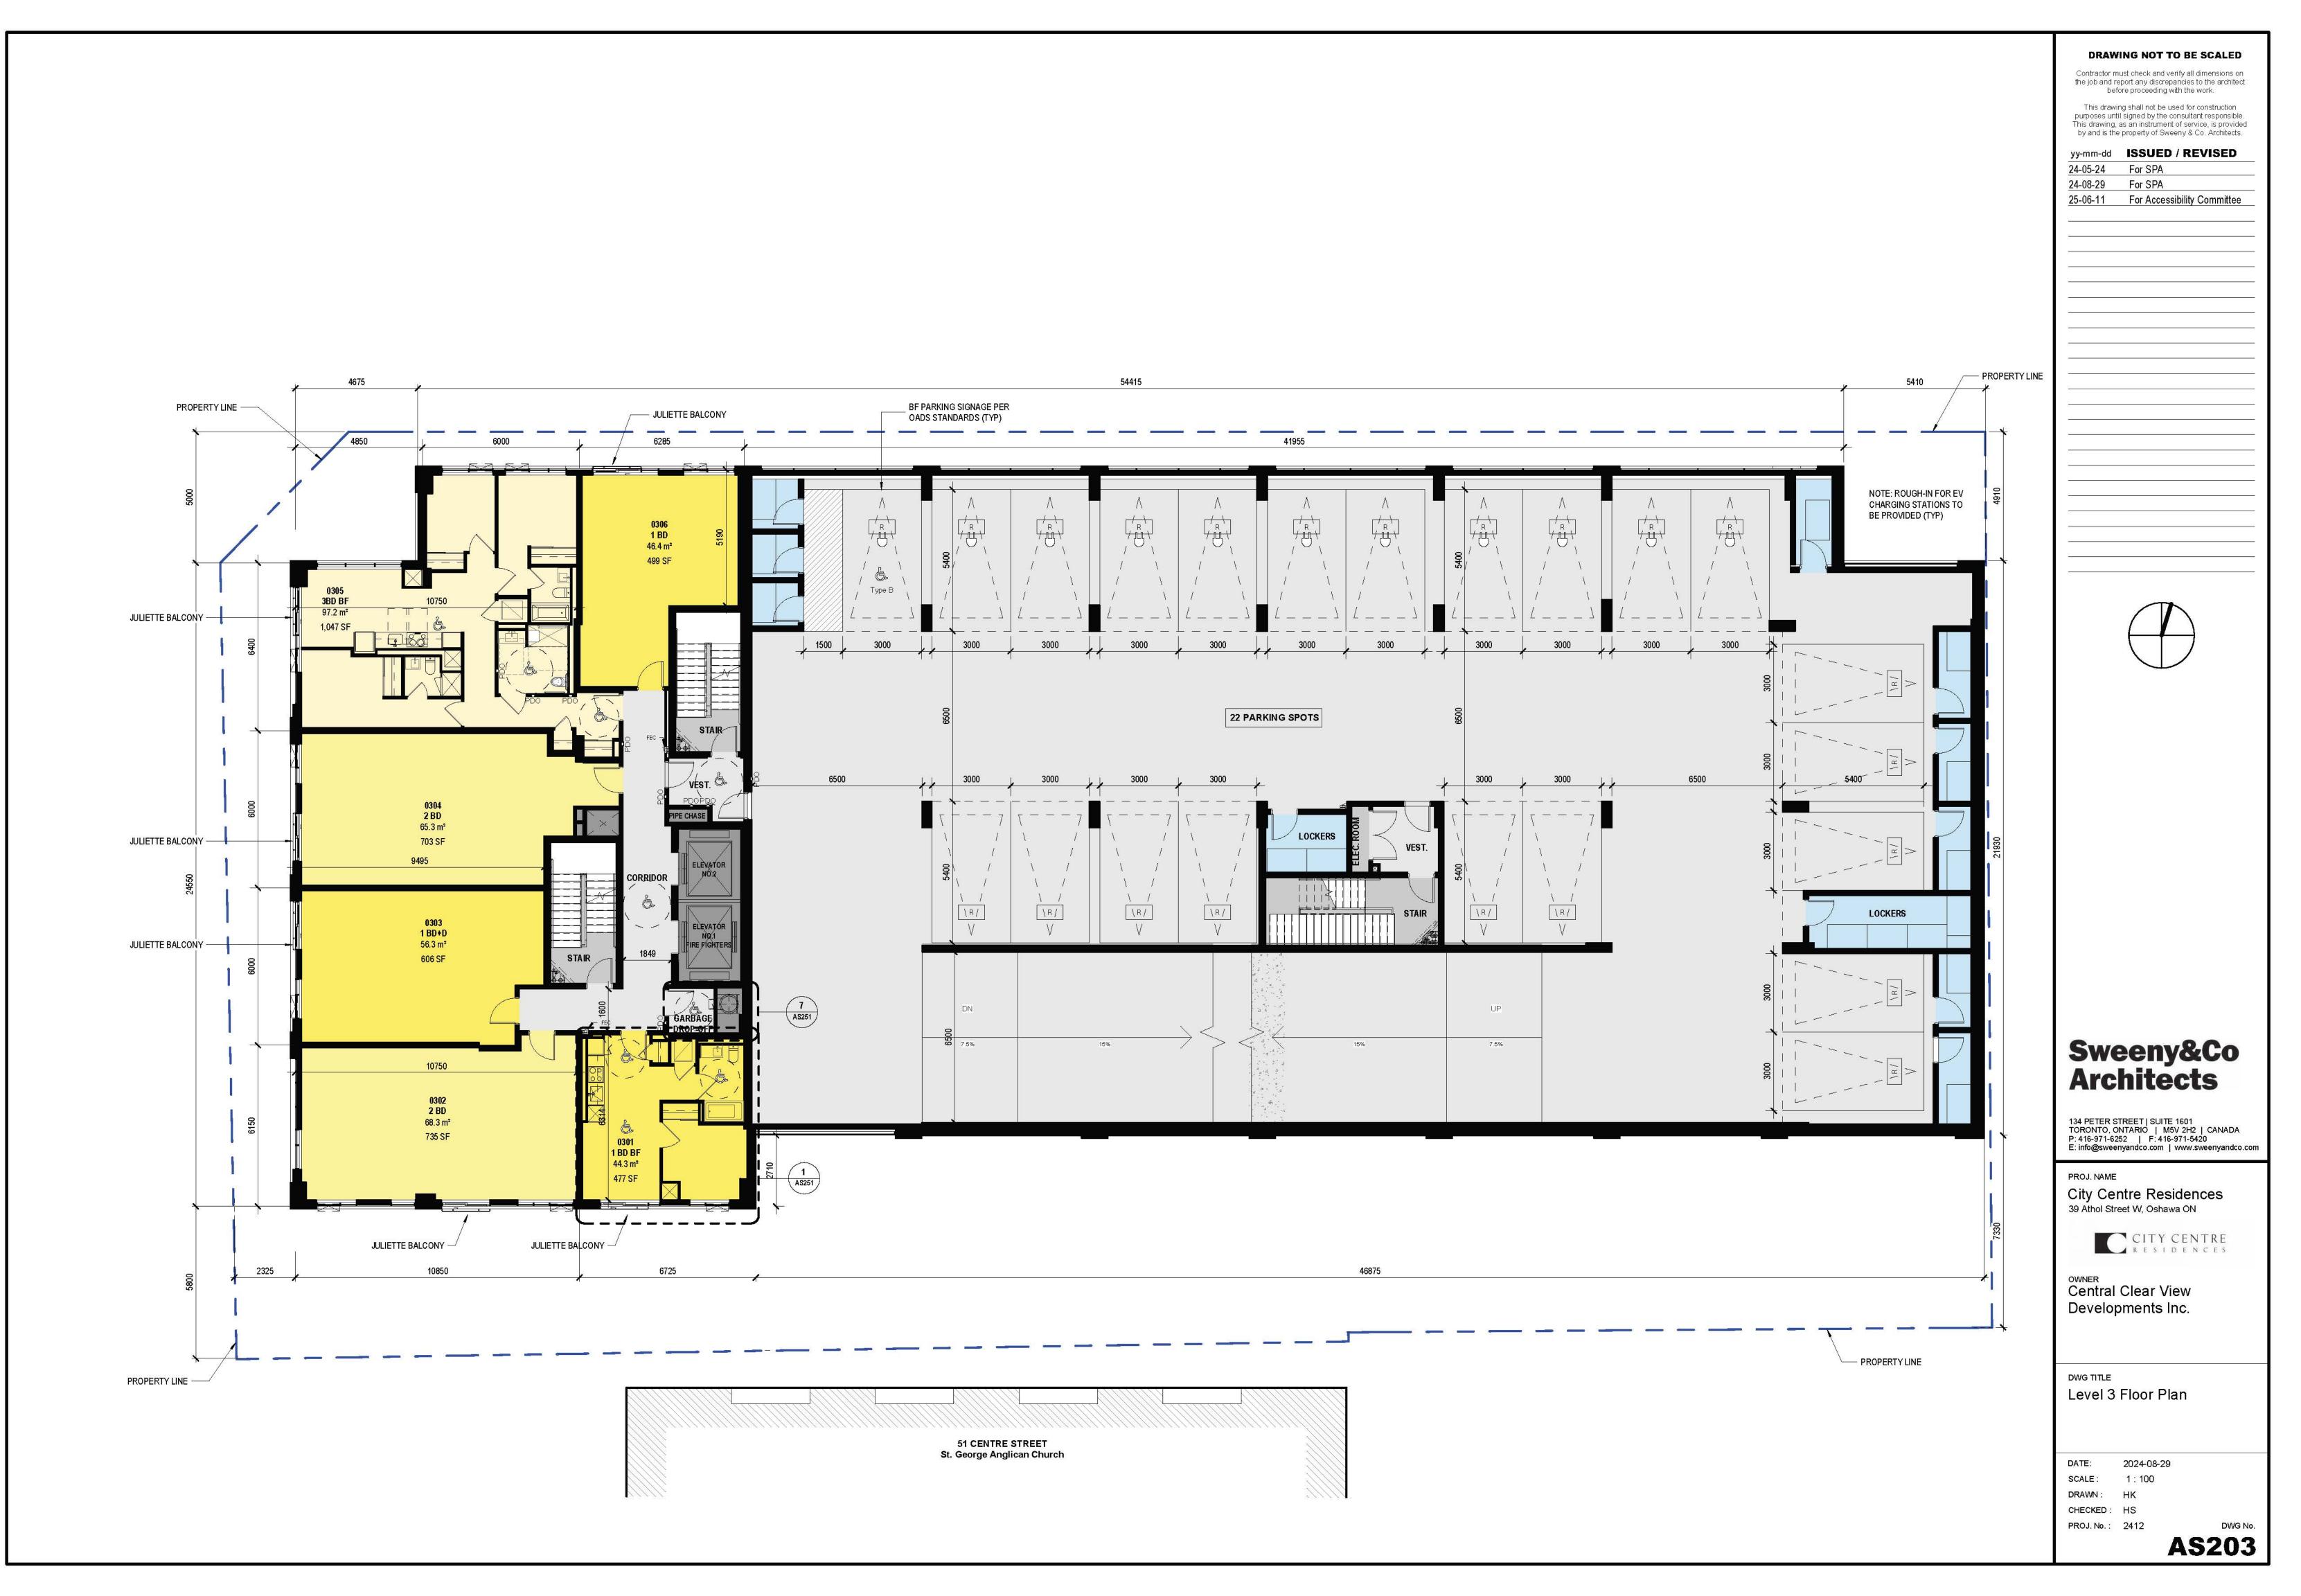




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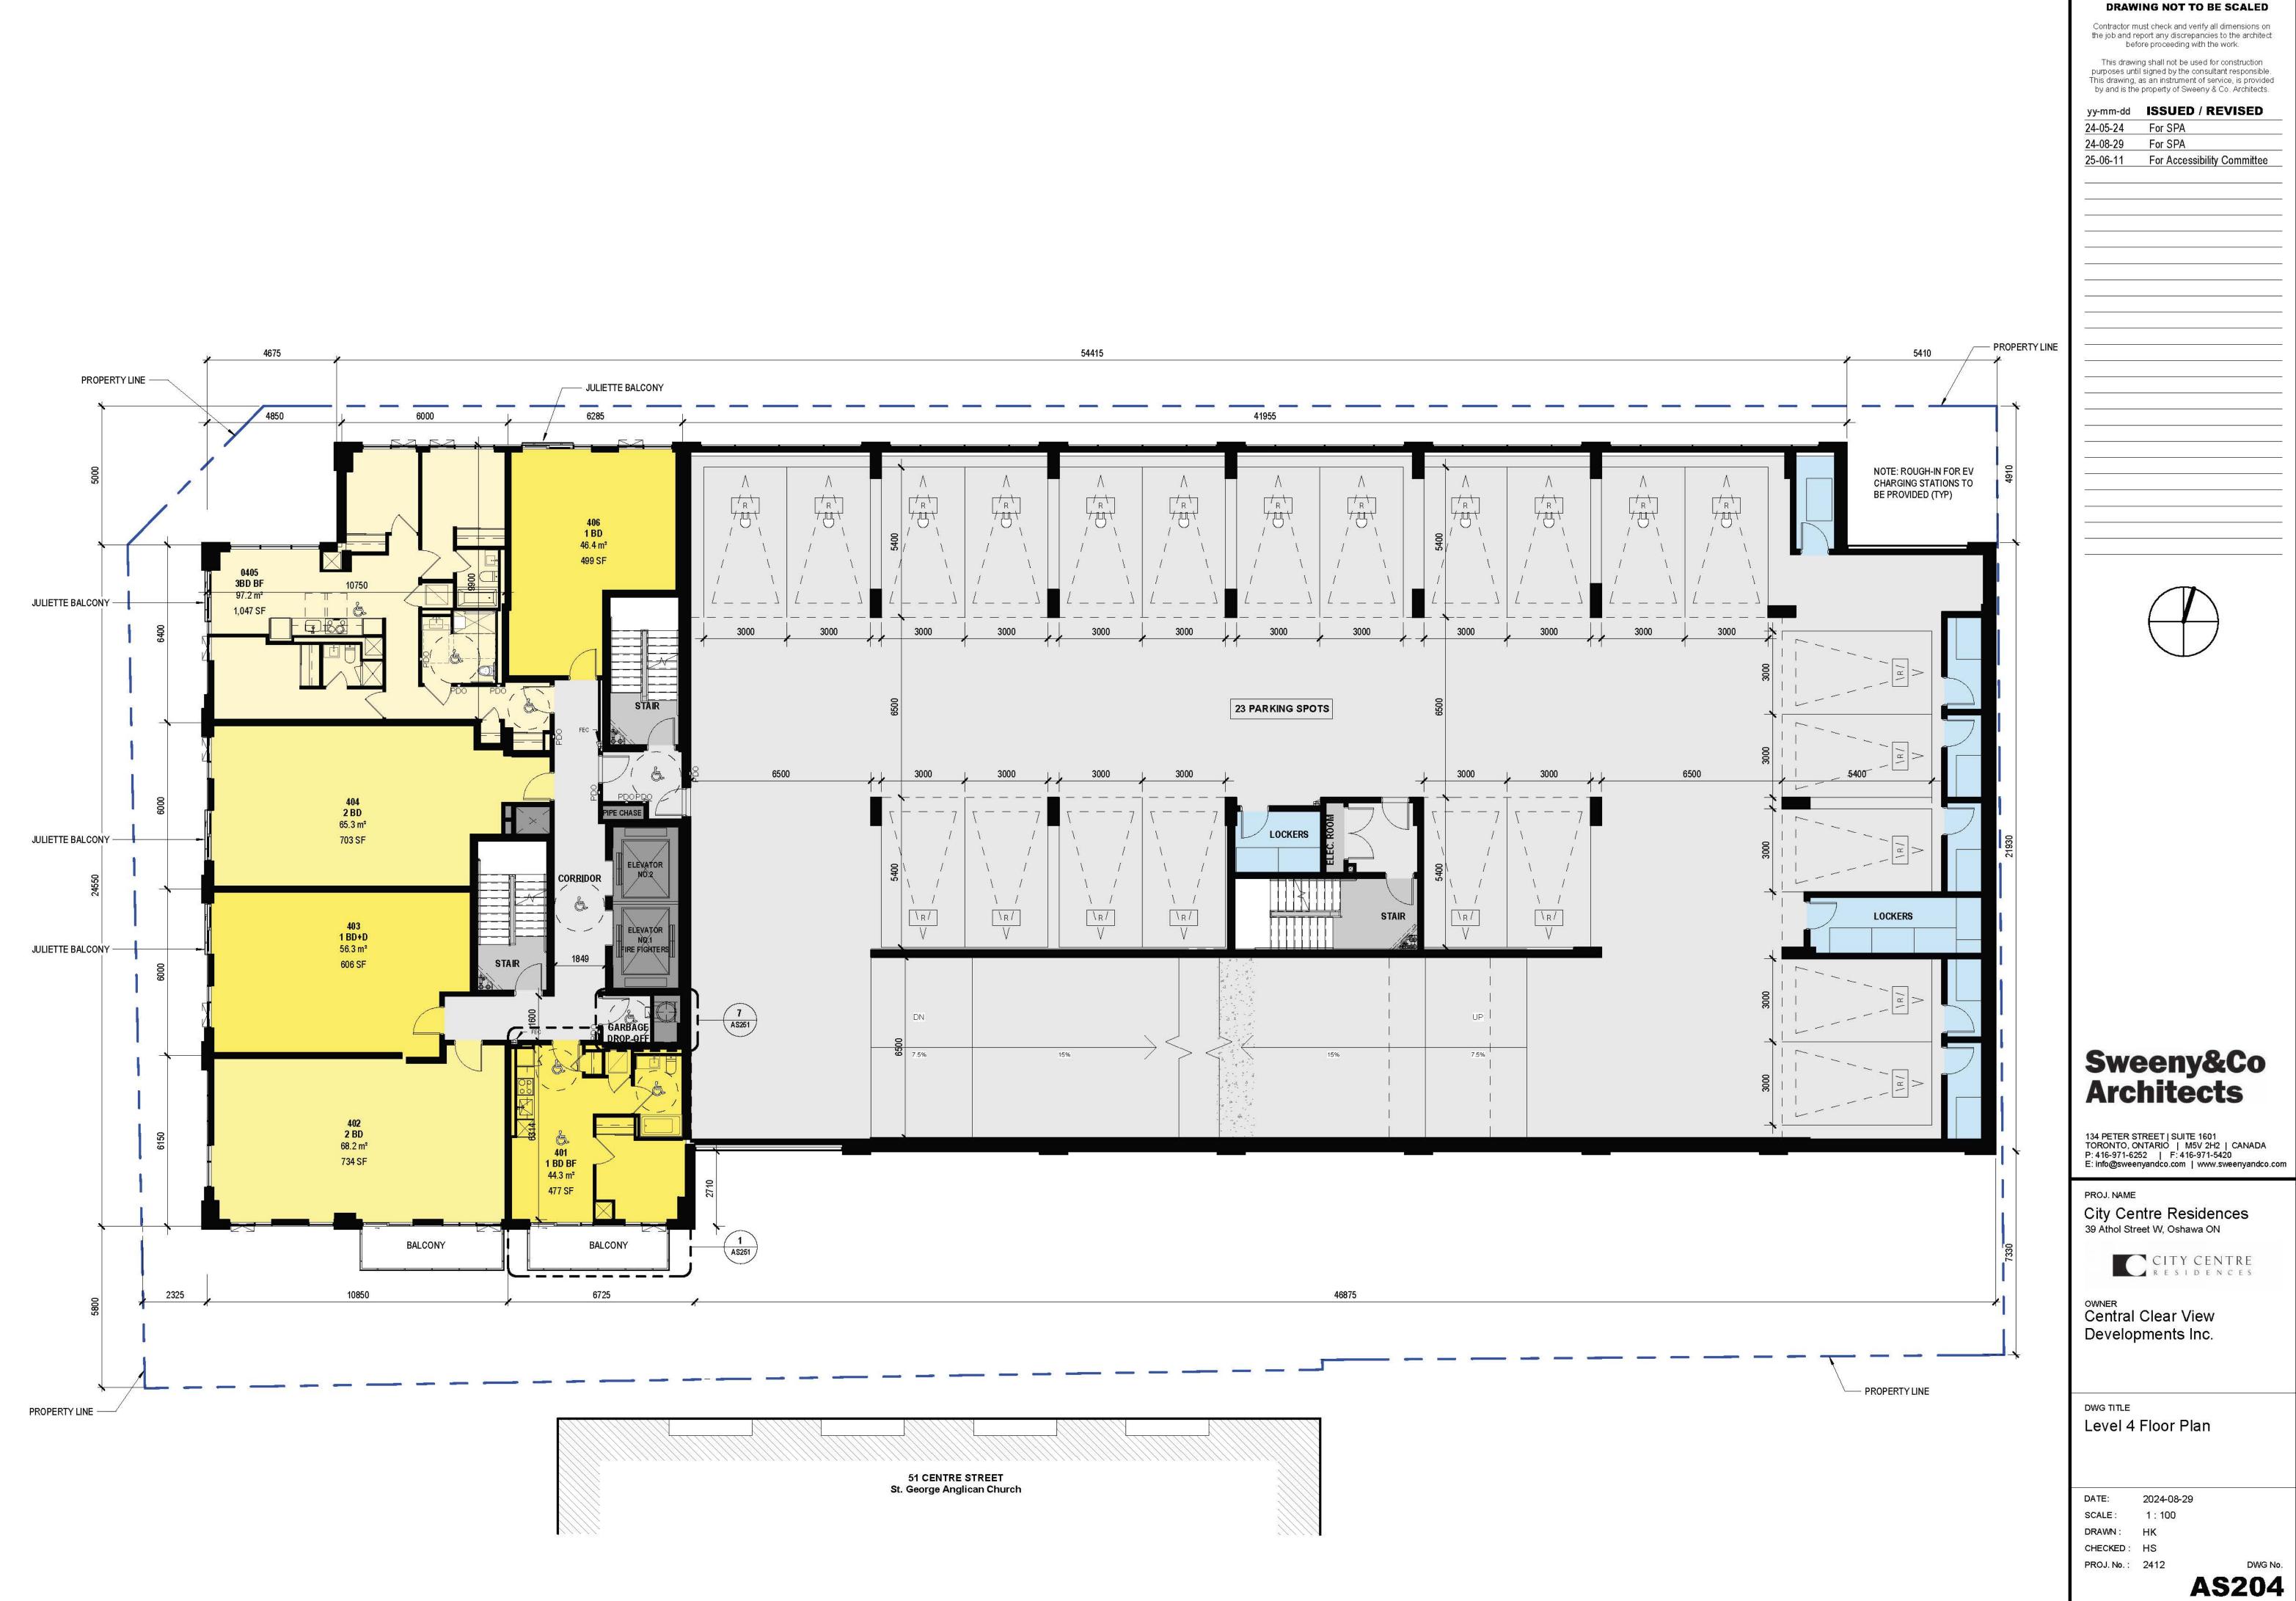
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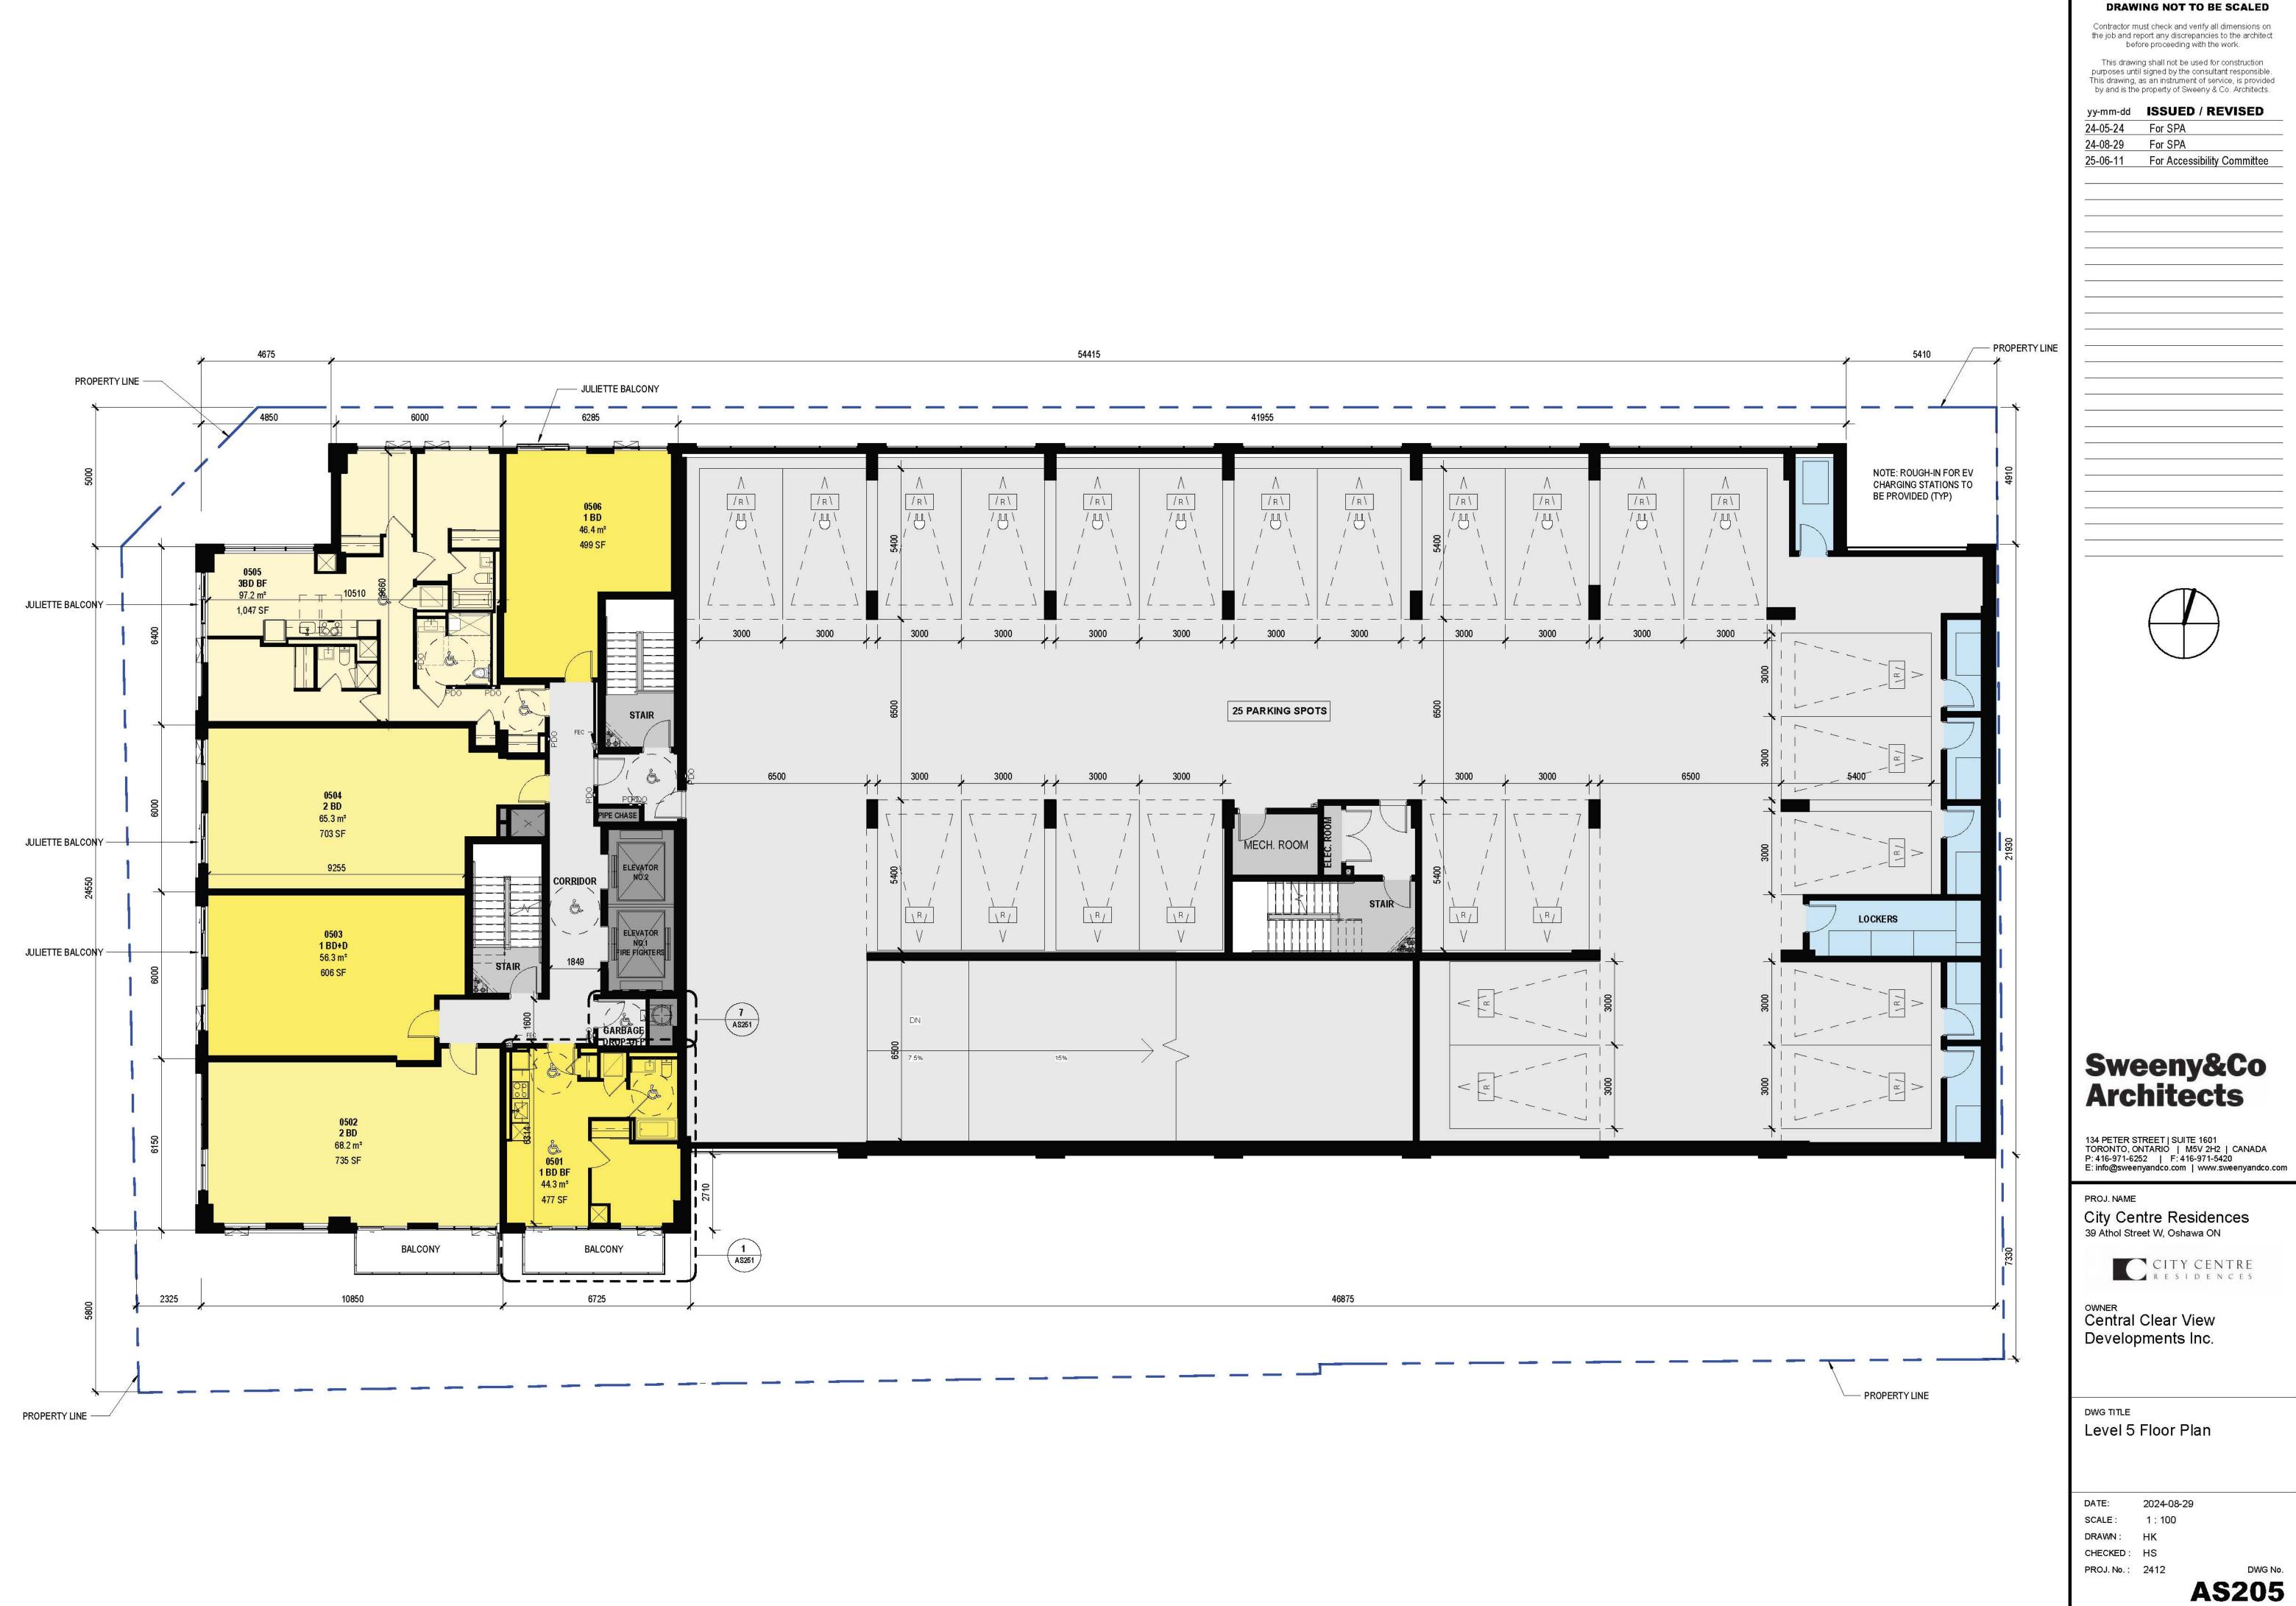


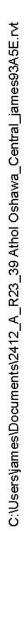


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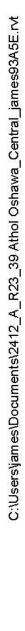
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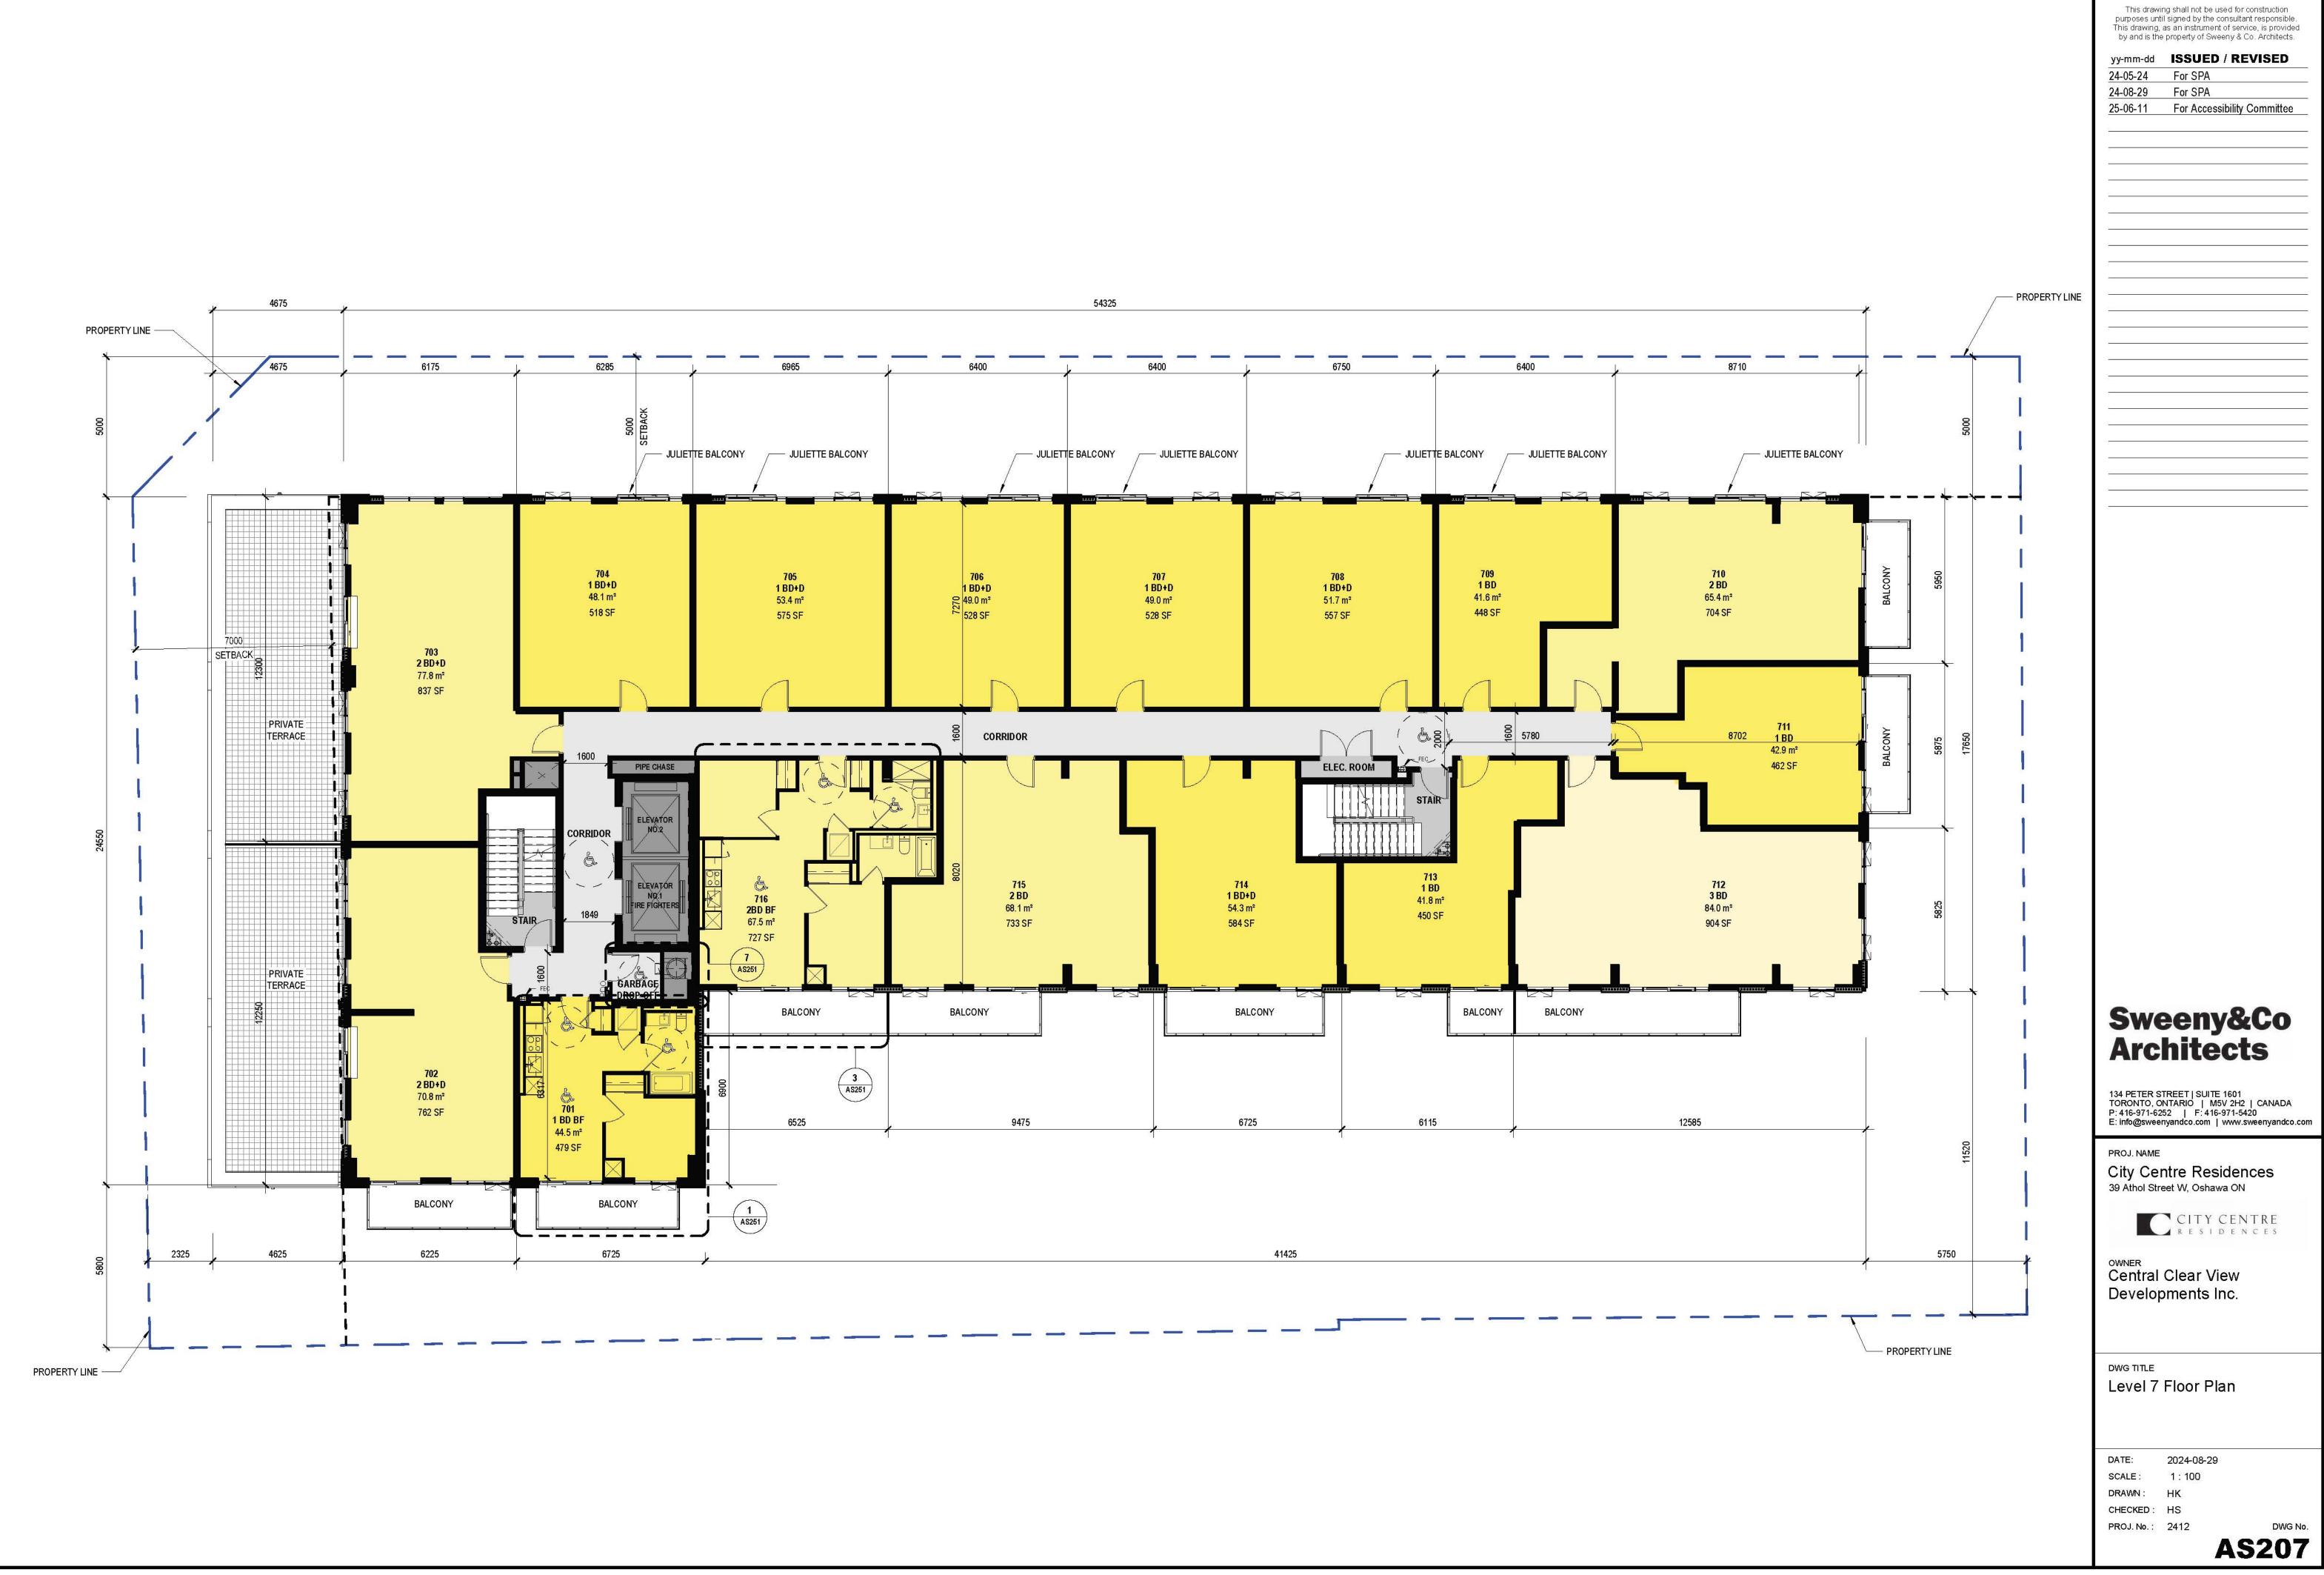






Contractor must check and verify all dimensions on the job and report any discrepancies to the architect before proceeding with the work.

This drawing shall not be used for construction



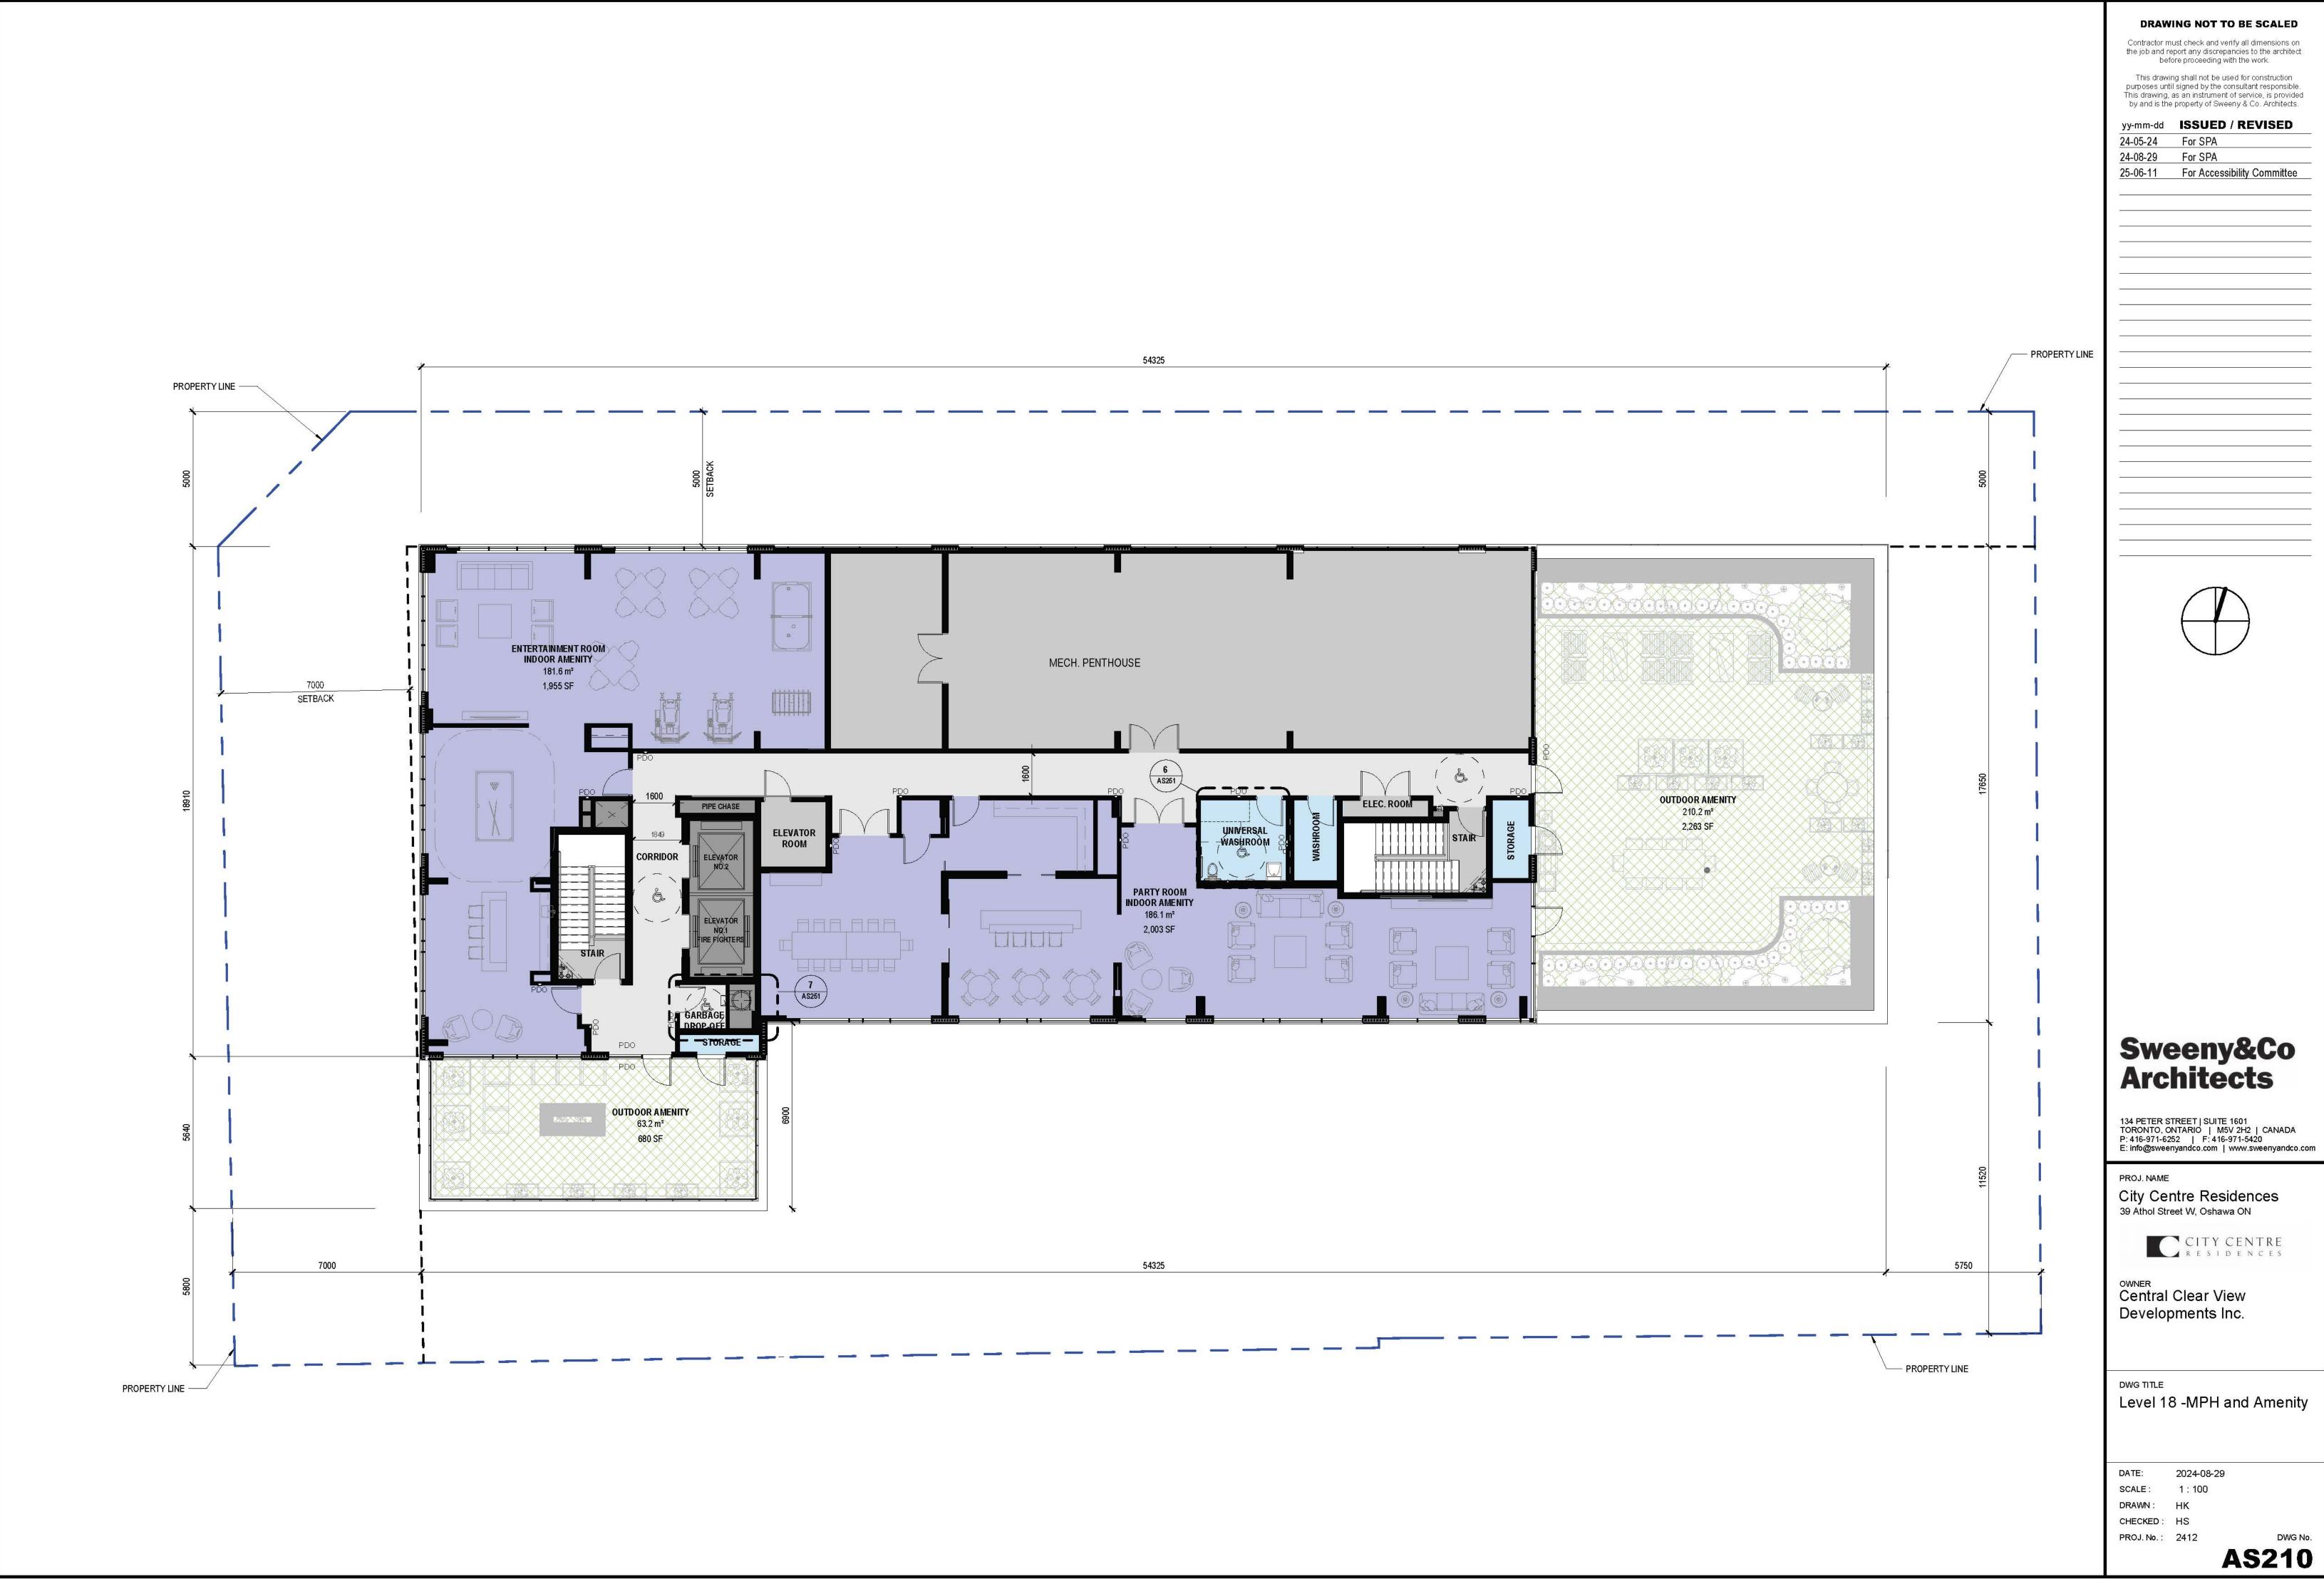
Contractor must check and verify all dimensions on the job and report any discrepancies to the architect before proceeding with the work.

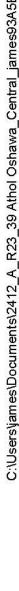


Contractor must check and verify all dimensions on the job and report any discrepancies to the architect before proceeding with the work.

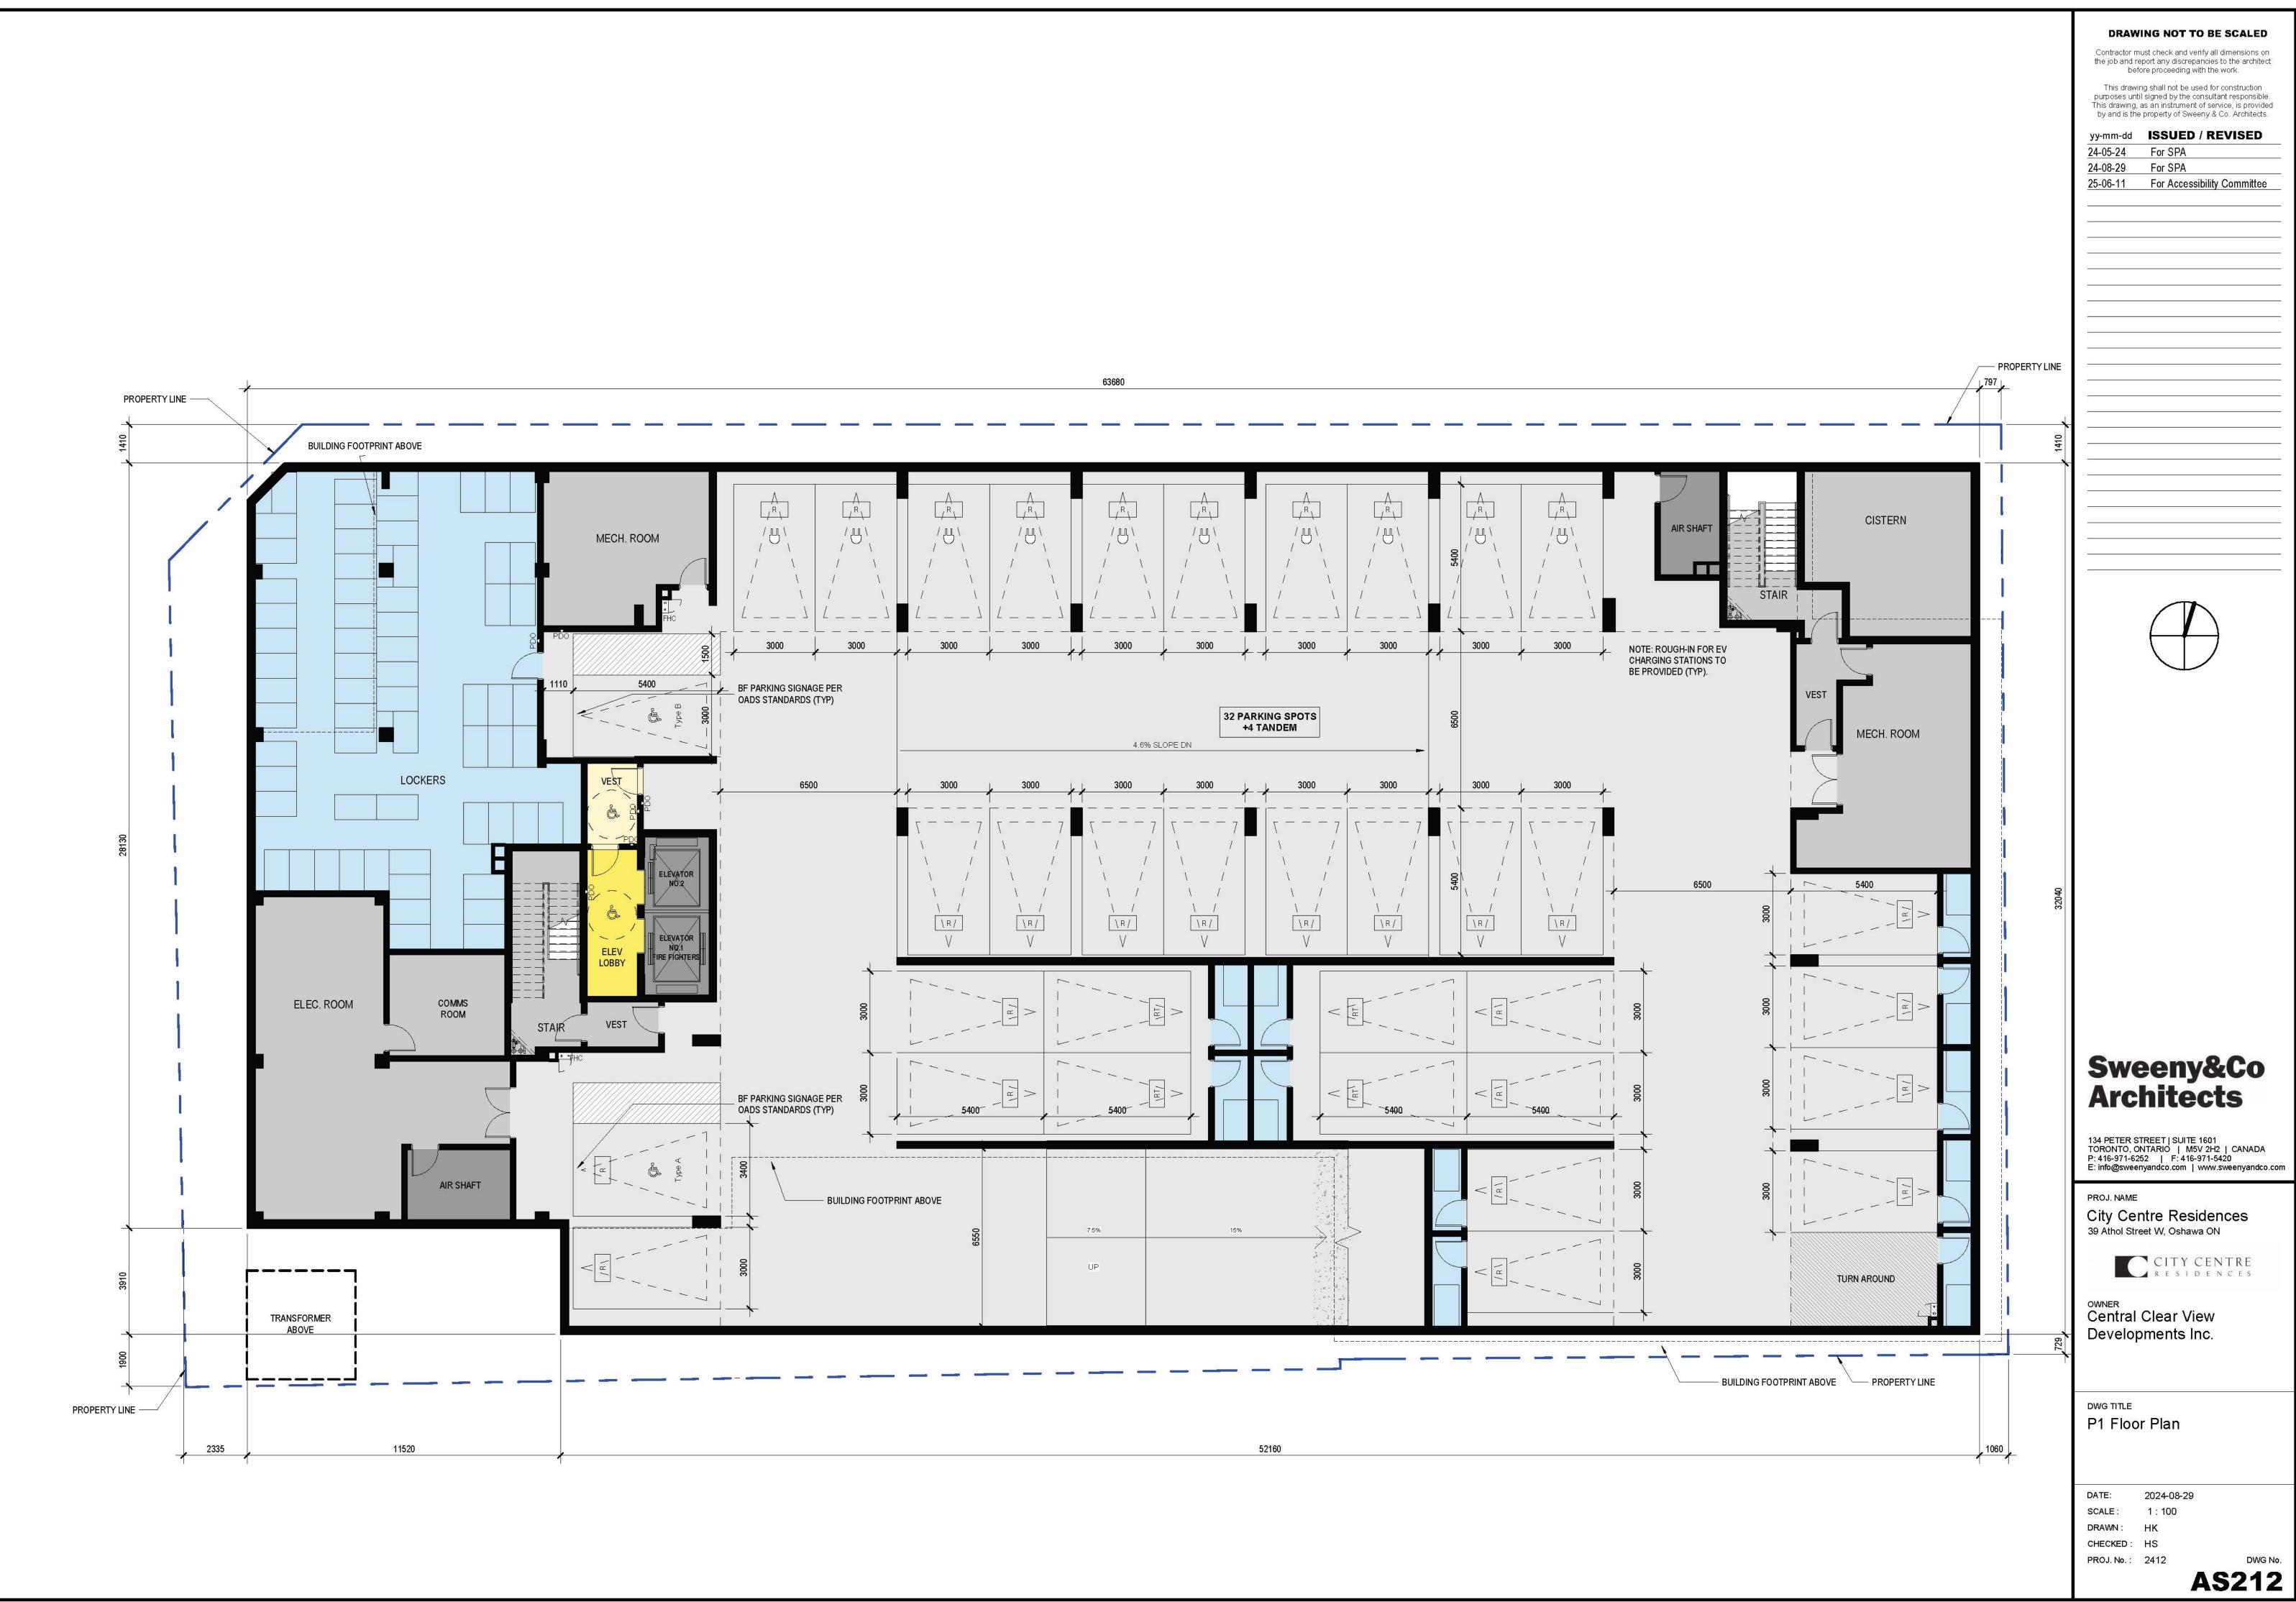


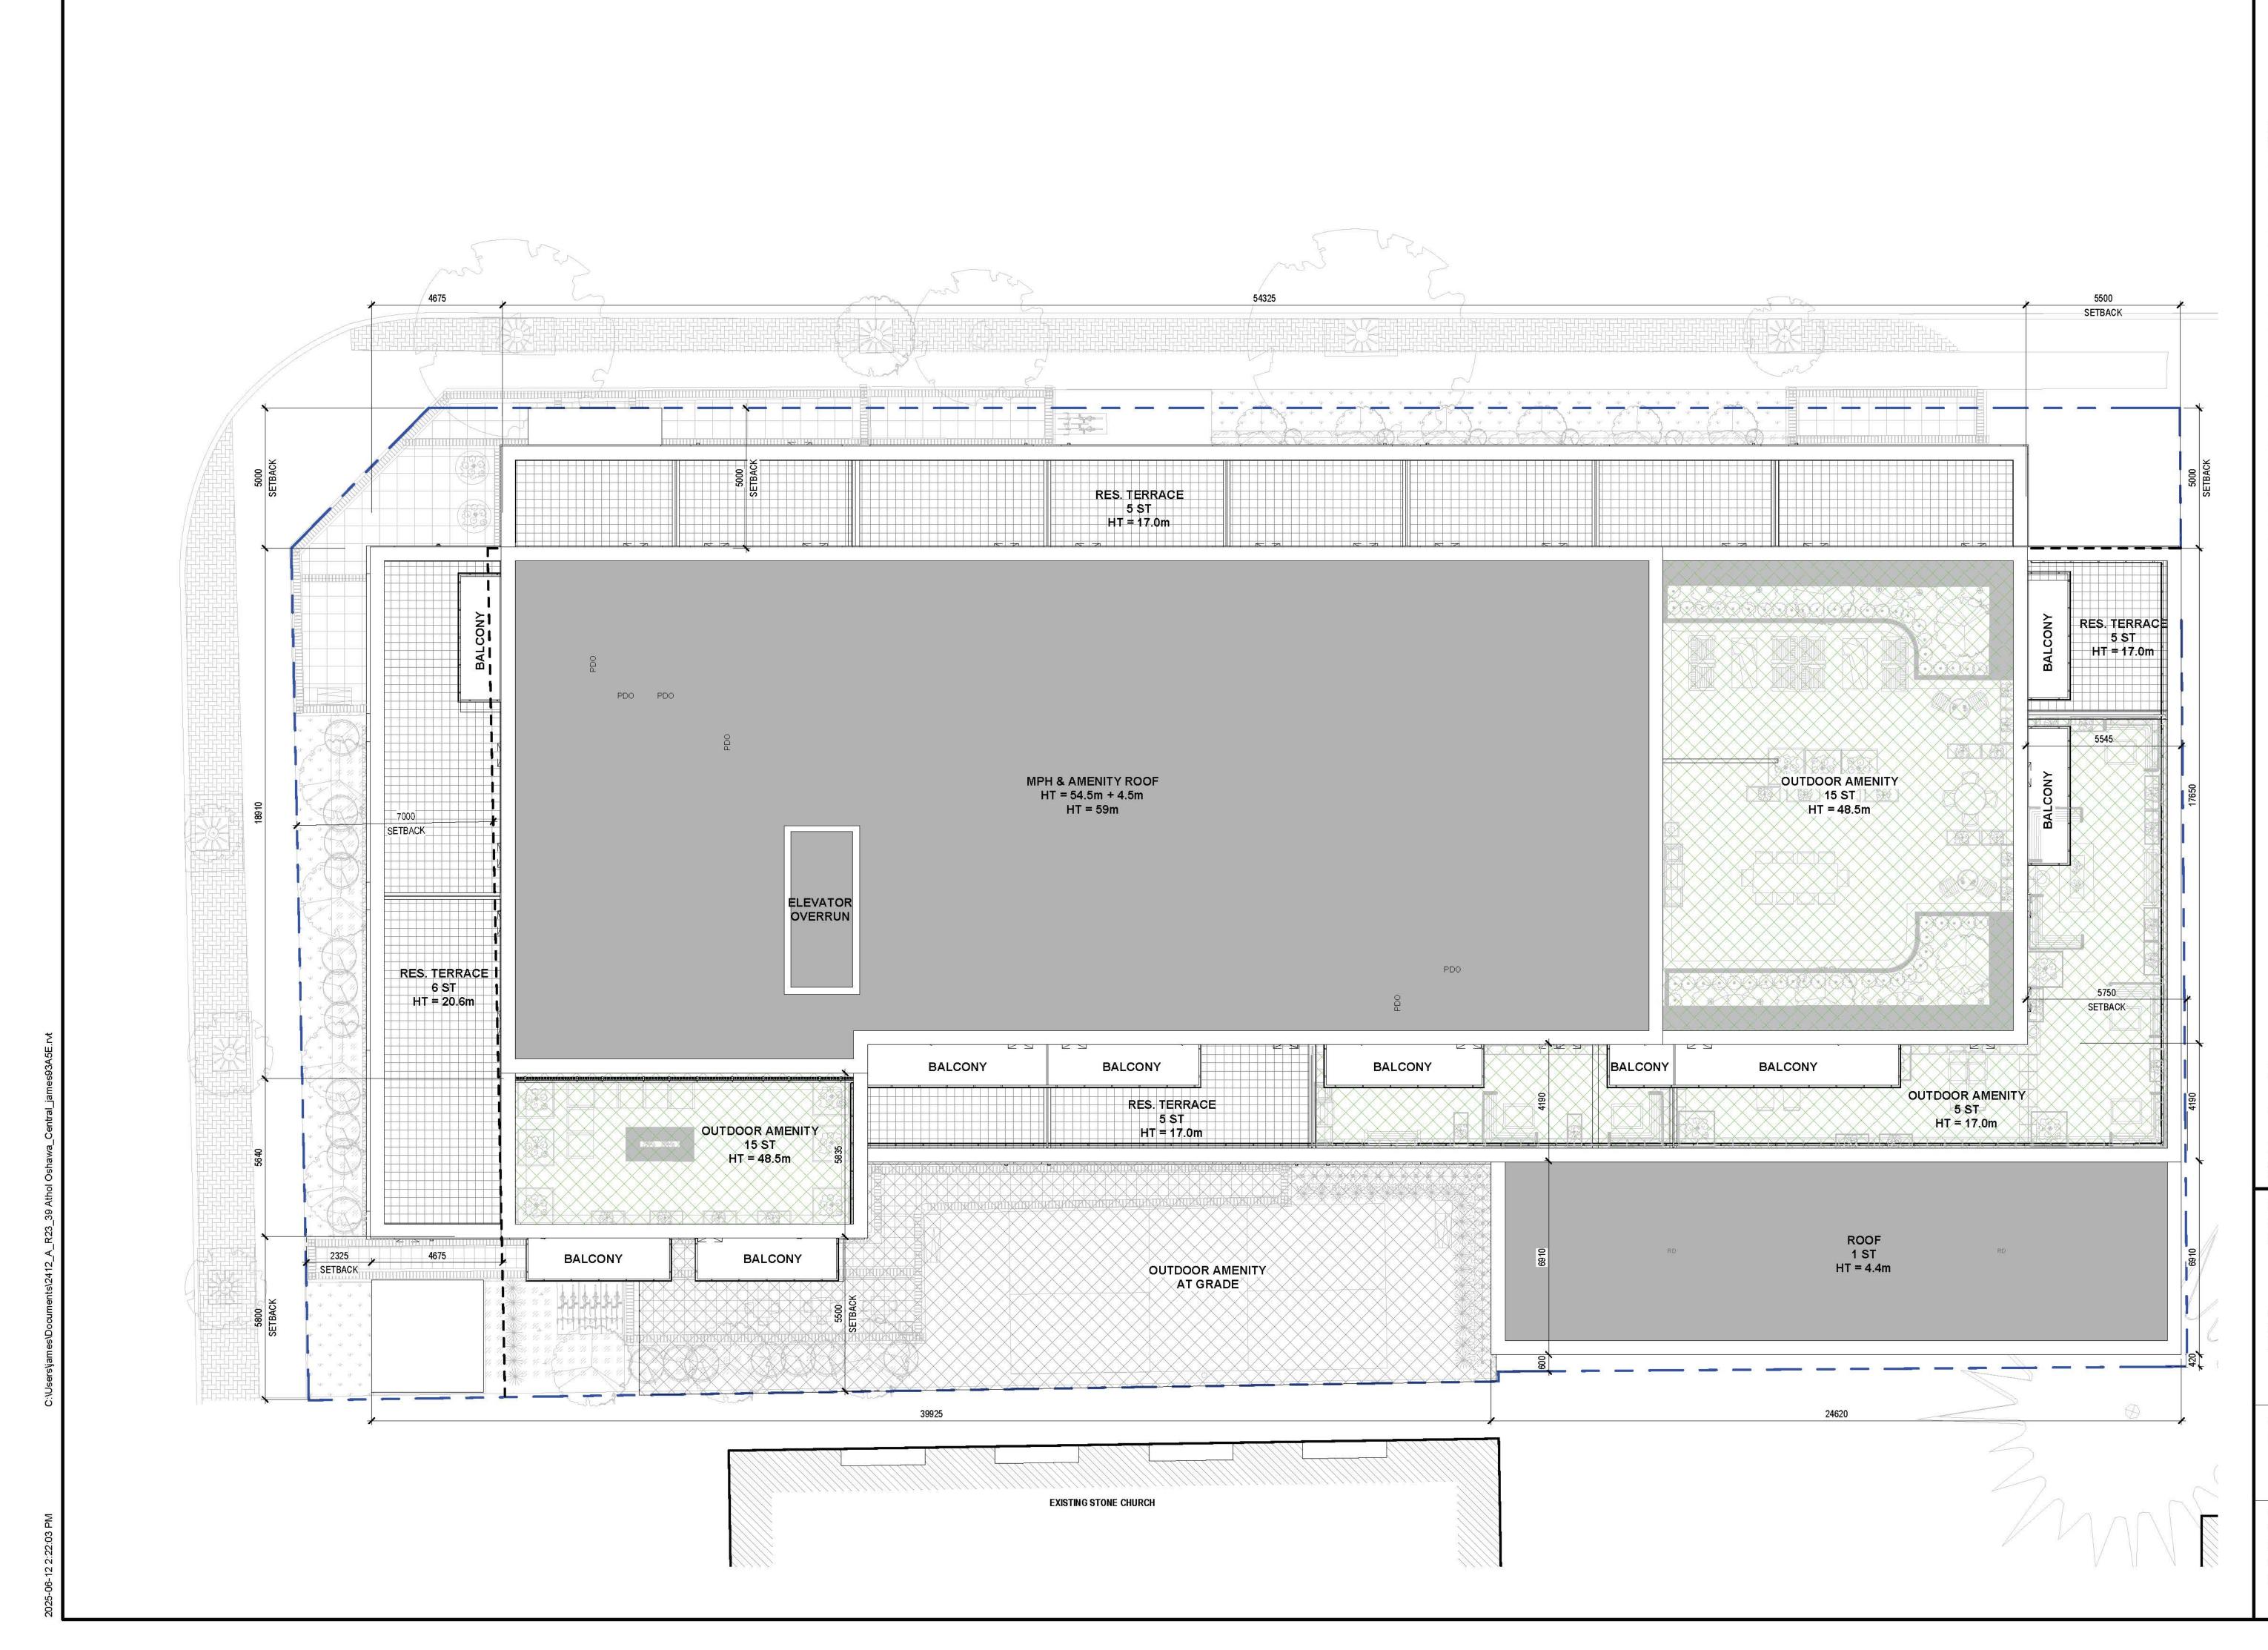
Contractor must check and verify all dimensions on the job and report any discrepancies to the architect before proceeding with the work.

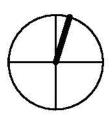














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PROJ. NAME City Centre Residences 39 Athol Street W, Oshawa ON

^{OWNER} Central Clear View Developments Inc.

^{DWG TITLE} Roof Plan

 DATE:
 2024-08-29

 SCALE:
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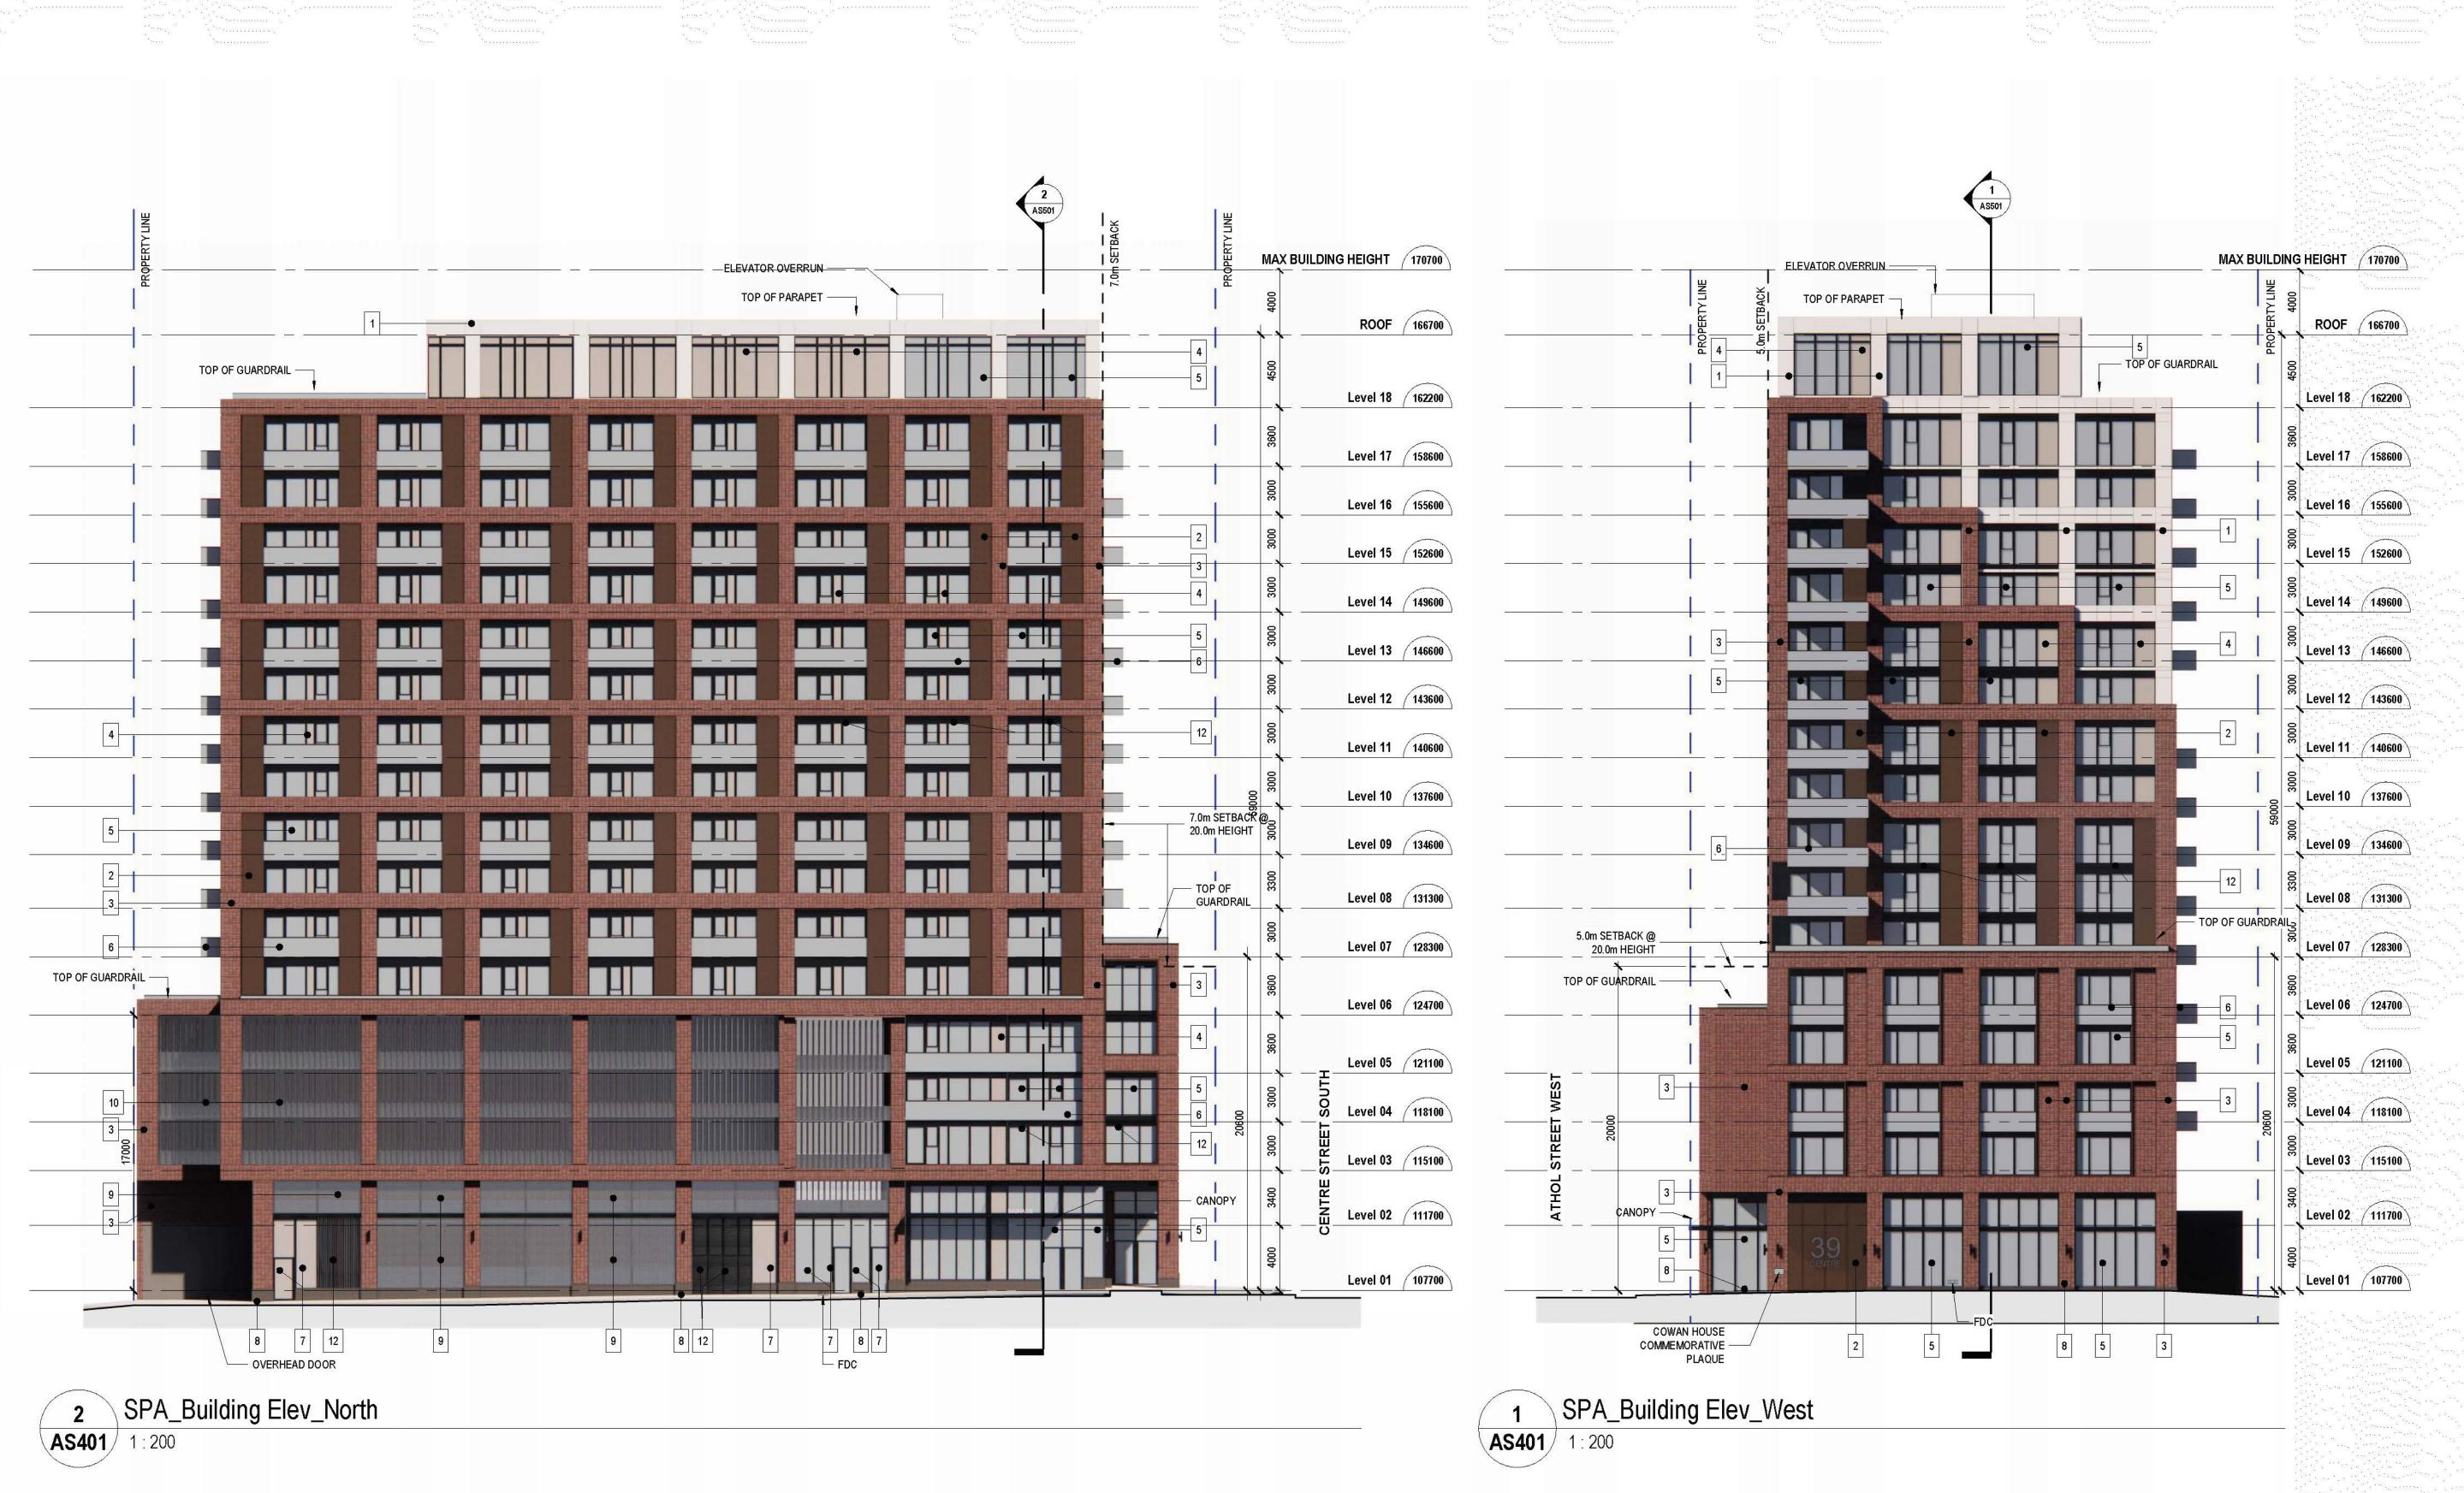
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 2412
 DWG No.

 ASS211





FOI ACCESSIDING COMMIN ZU-00-111 9 10 11 12 Louvre 13 Spandrel Panel - Shadow Box Glass



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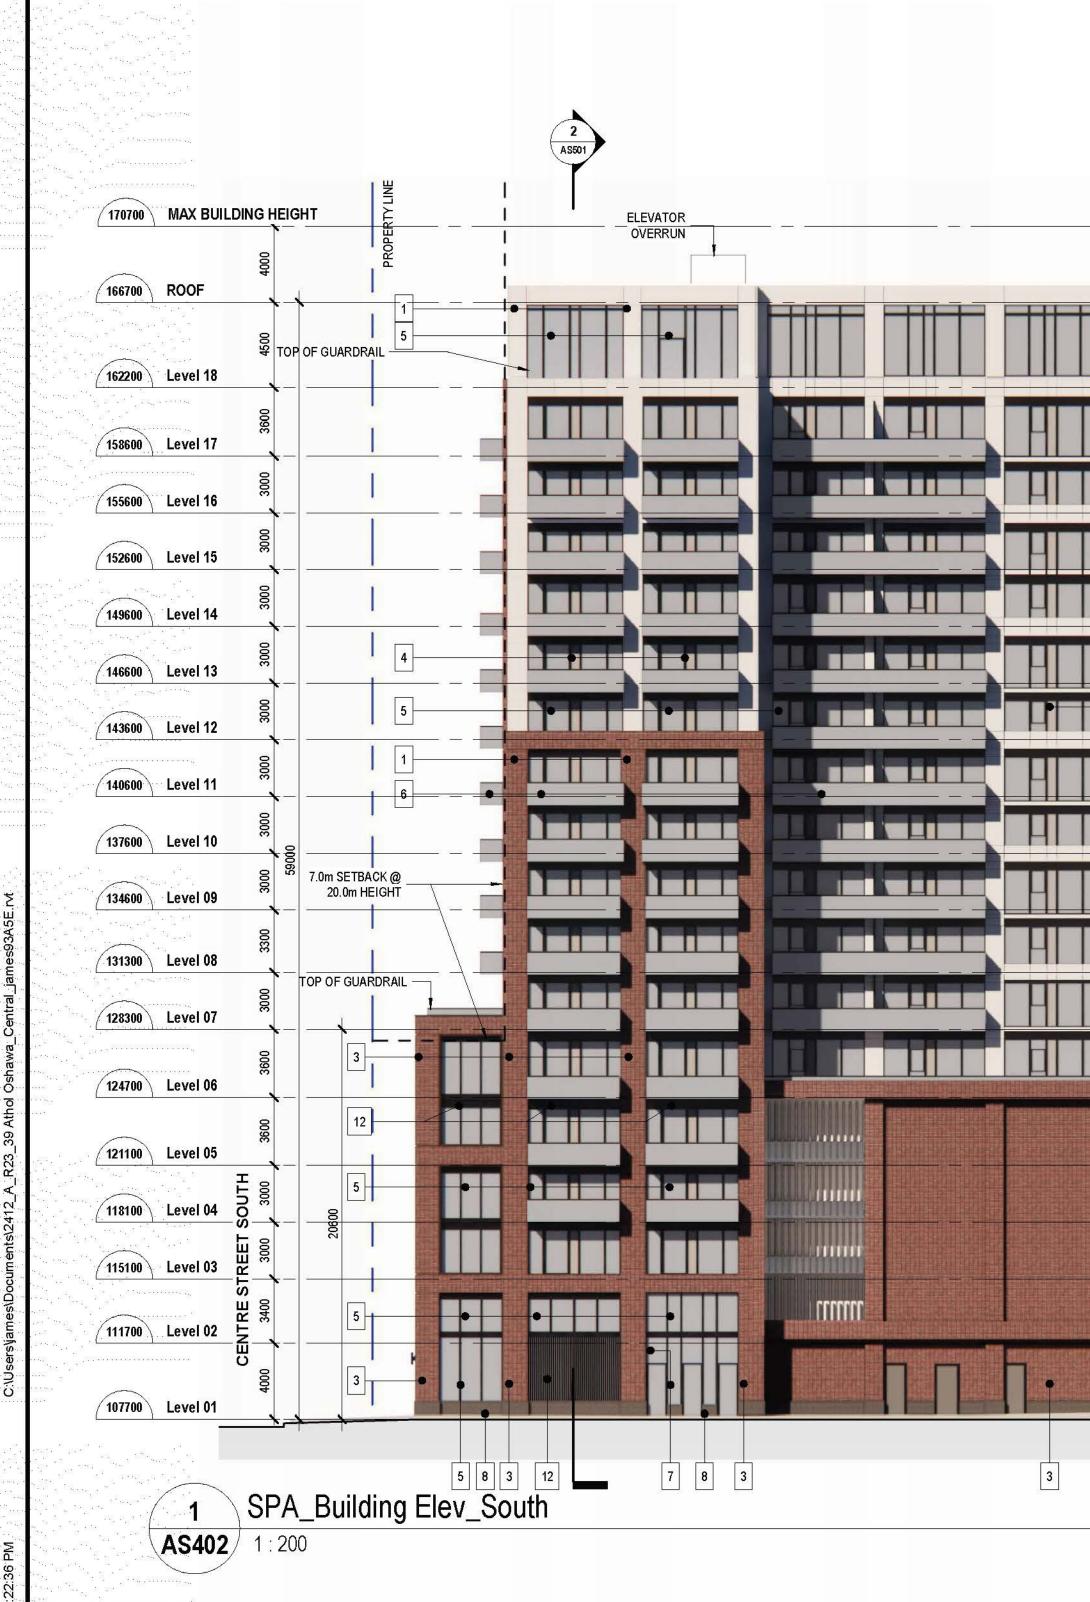
PROJ. NAME City Centre Residences 39 Athol Street W, Oshawa ON



OWNER Central Clear View Developments Inc.

DWG TITLE North and West Elevations

2024-08-29 DATE: SCALE : 1:200 DRAWN : HK CHECKED : HS PROJ. No.: 2412 DWG No. **AS401**



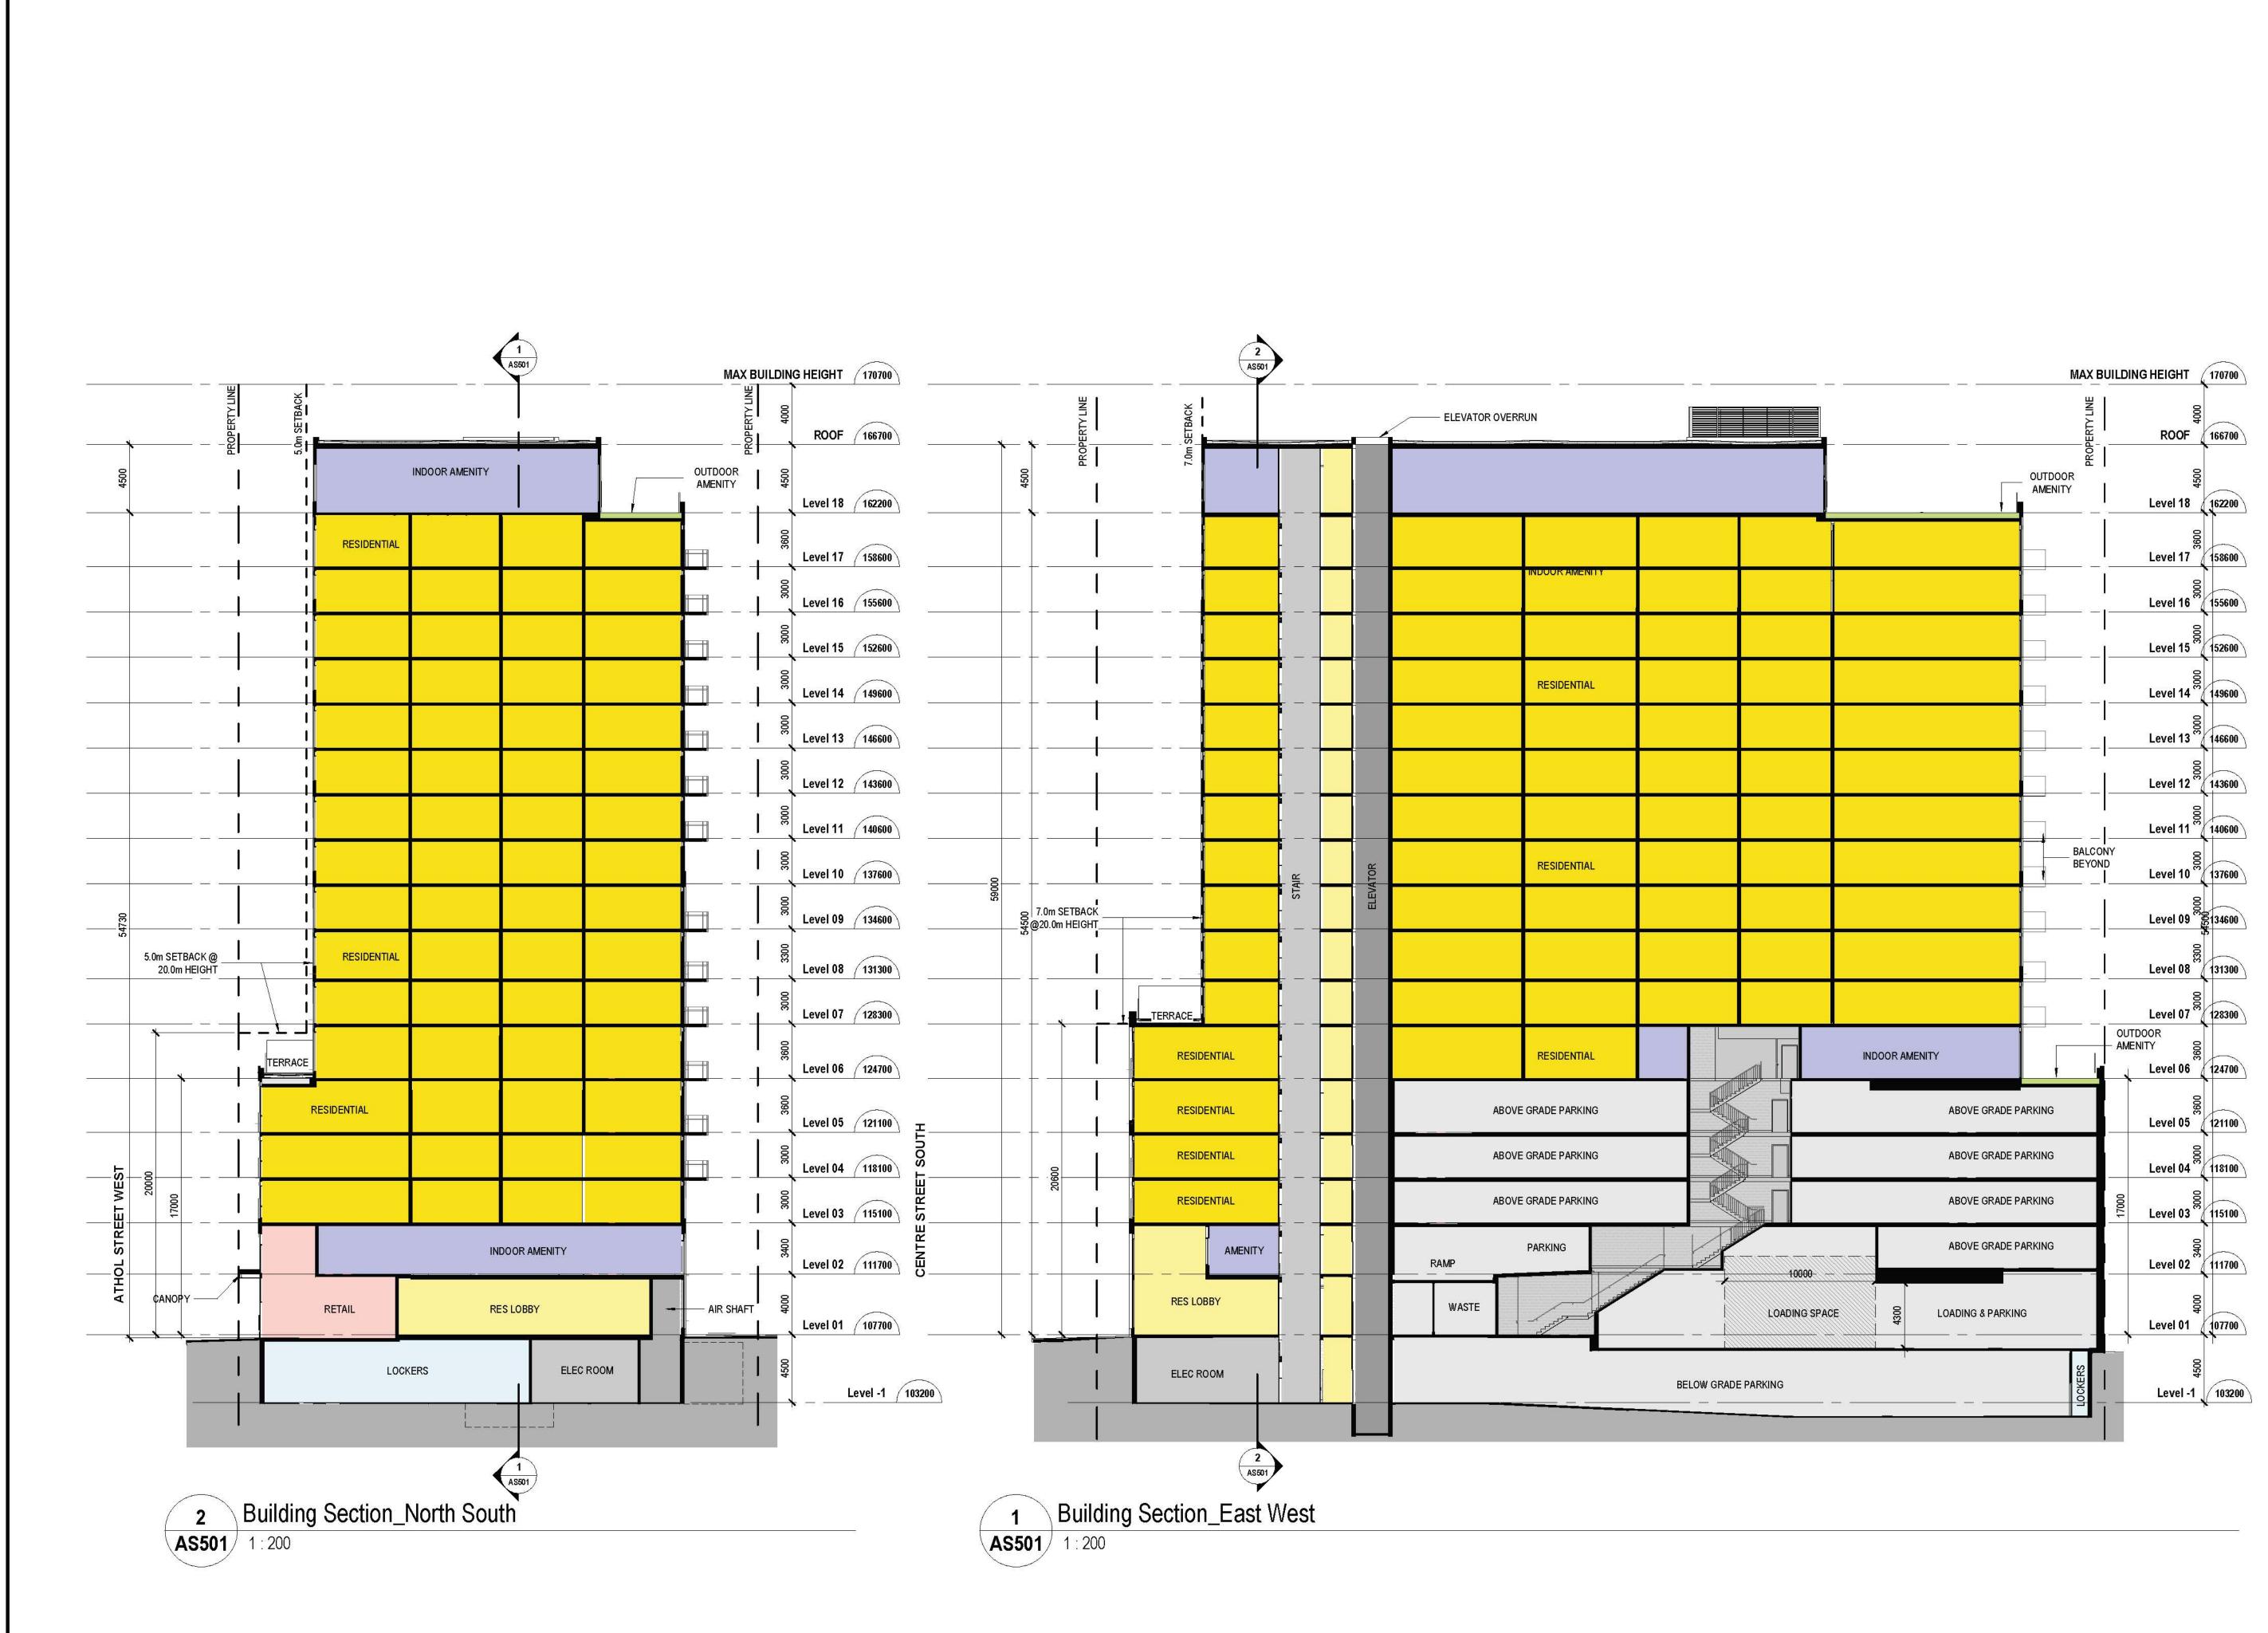
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Arc	hitects
TORONTO, O	TREET SUITE 1601 NTARIO M5V 2H2 CANADA
P: 416-971-62	52 F: 416-971-5420 nyandco.com www.sweenyandco.com
PROJ. NAME	ntre Residences
	eet W, Oshawa ON
	CITY CENTRE Residences
^{owner} Central	Clear View
1	oments Inc.
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